
638 NW LOCUST STREET, ISSAQUAH

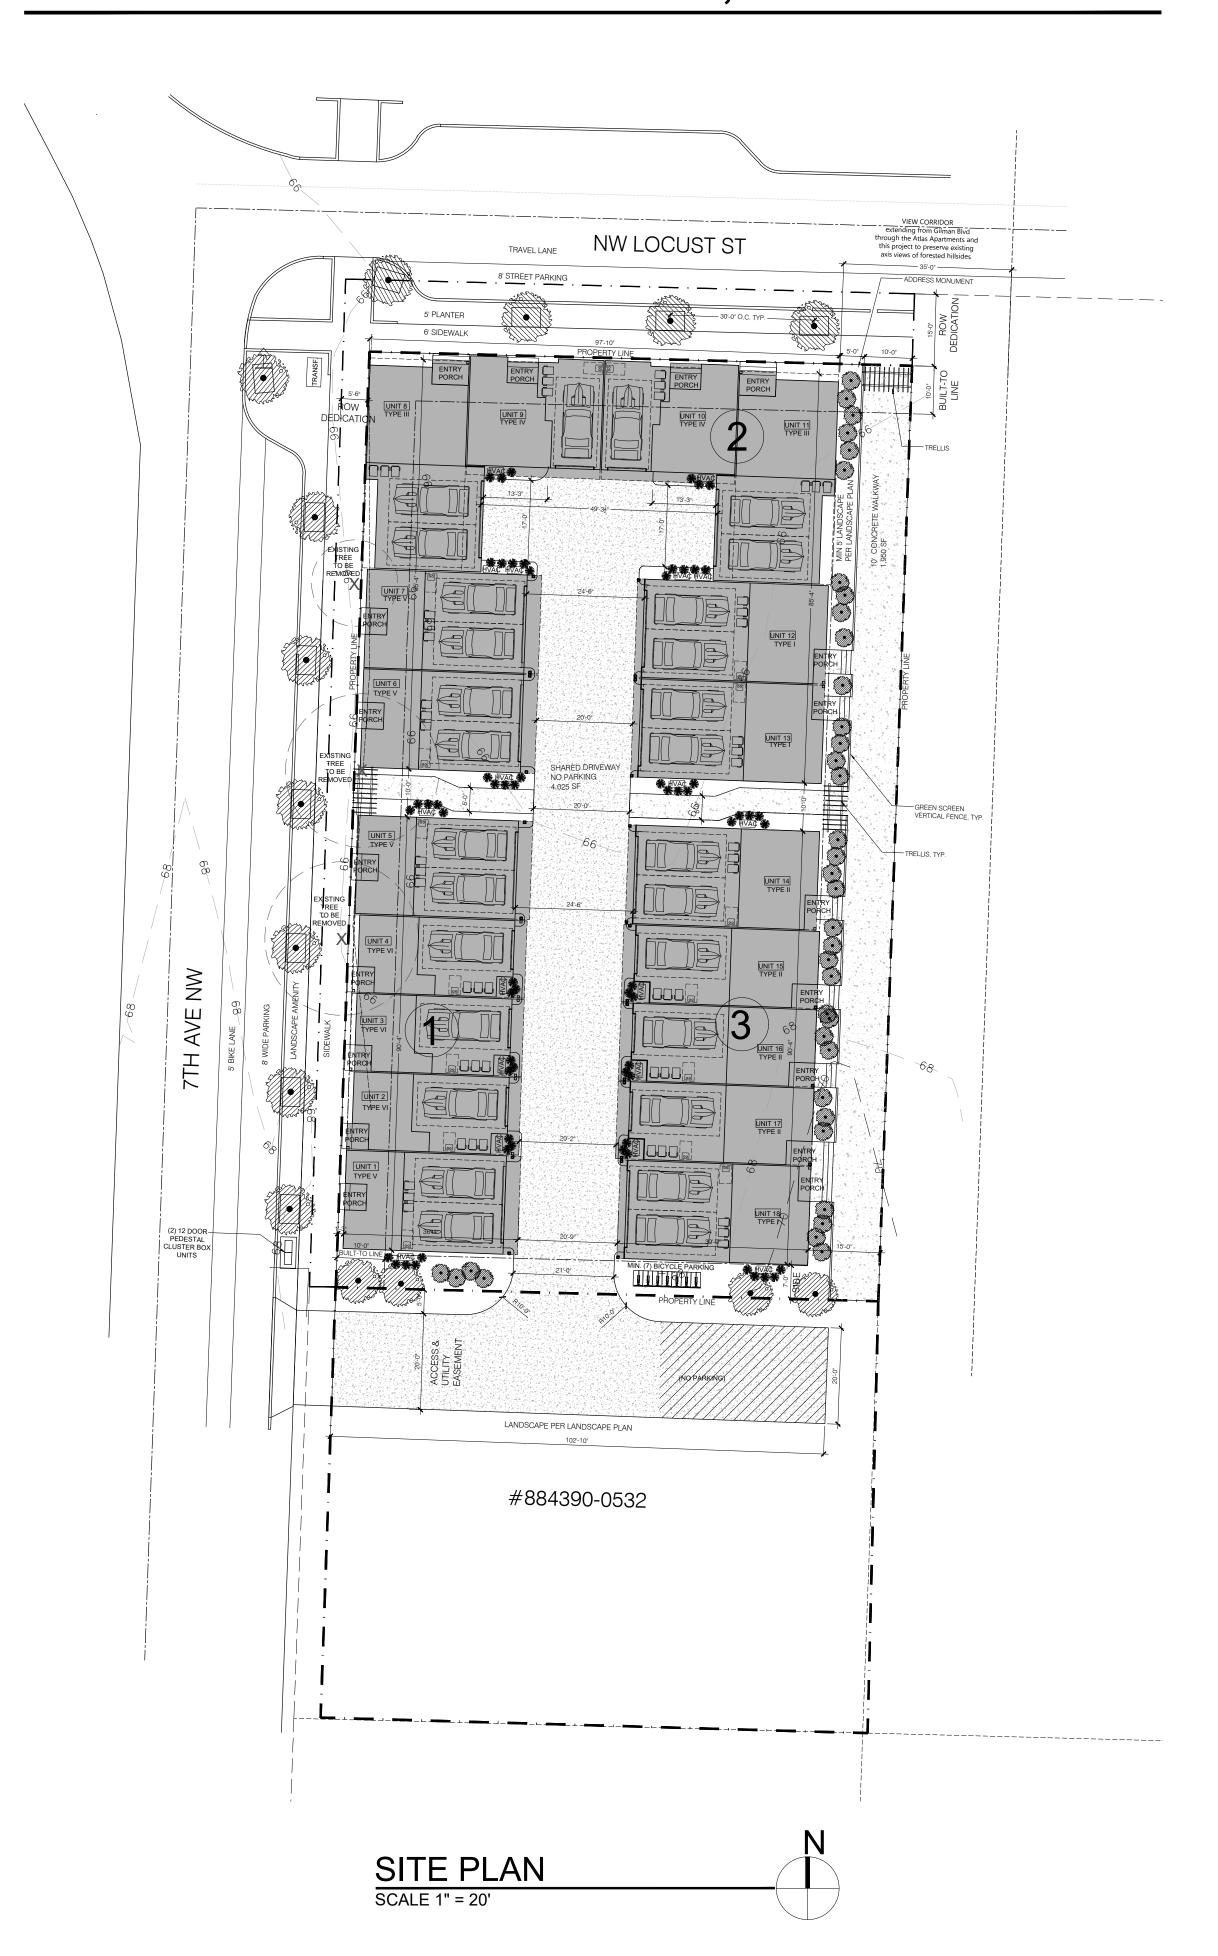

ZONING & CODE INFORMATION

ADDRESS: 683 NW LOCUST ST JURISDICTION: CITY OF ISSAQUAH

ZONING:

OVERLAY: **CENTRAL ISSAQUAH - TRADITIONAL**

8843900530, 8843900531 PARCEL ASSESSOR'S #: 24,901 SF

(per survey before ROW deductions)

LEGAL DESCRIPTION:

IRC TOWNHOUSES w FIRESEPARATIONS

and NFPA 13-D FIRE SPRINKLERS

CIDDS: **SETBACKS:**

LOT SIZE:

REQUIRED:

OCCUPANCY:

BUILD-TO-LINE - 0' - 10'

SIDE YARDS - 7'-0" REAR YARD -7'-0"

MAX HEIGHT ALLOWED:

PER CIDDS TABLE 4.4:

PER CIDDS TABLE 4.4: 40' ABOVE AEG

to the midpoint of the highest gable

PARKING:

VEHICULAR: 1 per unit BICYCLE: .15 per bedroom

BUILDING FRONTAGE:

MINIMUM REQUIRED 60% 126' & 68'

COMMUNITY SPACES:

REQUIRED:

INDIVIDUAL PRIVATE 48 SF per unit

IMPERVIOUS SURFACE:

LOT SIZE: 24,901 SF IMPERVIOUS SURFACE ALLOWED (80%) 19,921SF

TOTAL IMPERVIOUS SURFACE AS DIAGRAMMED: WALKWAYS, FRONT PORCHES, STEPS: 2,660 SF 3,045 SHARED DRIVEWAY: 13,206 SF **BUILDINGS**: TOTAL: 19,811 SF

LEGEND:

BUILDING FOOTPRINT

IMPERVIOUS PAVEMENT

LINE OF BUILDING ABOVE

BUILDING FOOTPRINT

PROPERTY LINE

SETBACK LINE **BUILT-TO LINE**

PROJECT DESCRIPTION:

CONSTRUCT AN EIGHTEEN-UNIT TOWNHOME PROJECT WITHIN THREE INDIVIDUAL BUILDINGS.

PROJECT TEAM:

OWNER / CONTRACTOR:

DRM PROPERTIES MARK MCFADYEN 411 5TH ST ANACORTES, WA 98221 P: 206.755.6041

E: mark.drmproperties@gmail.com

ARCHITECT:

MEDICI ARCHITECTS **EMILY BUCHWALTER, AIA** 11711 SE 8TH ST, SUITE 100 BELLEVUE, WA 98005 P: 425-453-9298 E: emily@mediciarchitects.com

CIVIL ENGINEER:

KEITH LITCHFIELD 12840 81ST AVE NE KIRKLAND, WA 98034 P: 425.821.5038 E: ka.litchfield@frontier.com

GEOTECHNICAL ENGINEER: GEO GROUP NORTHWEST, INC WILLIAM CHANG

13240 NE 20TH STREET, STE 10 BELLEVUE, WA 98005

P: 425-649-8757

LANDSCAPE: **CRAIG LEWIS**

12610 NE 104TH ST KIRKLAND, WA 98033 P: 425.454.5723 E: craig@jgm-inc.com

SURVEYOR: TERRANE

EDWIN GREEN 10801 MAIN ST, SUITE 102

BELLEVUE, WA 98004 P: 425.458.4488 E: support@terrane.net

BUILDING CLASSIFICATION

A. OCCUPANCY CLASSIFICATION:SINGLE FAMILY RESIDENCE B. TYPE OF CONSTRUCTION: 1. AUTOMATIC SPRINKLERS PROVIDED X YES NO

SPRINKLER SYSTEM TO BE A FLOW THRU SYSTEM TYPE V.B

2. TYPE OF CONSTRUCTION:

FLOOR AREA PER BUILDING:

BUILDING 1: 3,790 SF (2) TYPE V (3) TYPE VI 4,300 SF TOTAL: 8,090 SF

BUILDING 2: (2) TYPE I 3,478 SF (2) TYPE III 3,812 SF (2) TYPE IV 3,126 SF (2) TYPE V 3,790 SF TOTAL: 14,206 SF

BUILDING 3:

79.6%

(1) TYPE I 1,739 SF (4) TYPE II 5,684 SF TOTAL: 7,423 SF

FAR CALCS:

LOT SIZE: 24,901 SF FLOOR AREA RATIO: 1.25 FAR ALLOWED: 31,126 SF 8,090 SF **BUILDING 1 BUILDING 2** 14,206 SF **BUILDING 3** 7,423 SF TOTAL FAR: 29,718 SF (1.19)



PROJECT LOCATION

VICINITY MAP



ARCHITECTURAL SHEET INDEX

PROJECT LOCATION

QT. SECT. MAP

TITLE SHEET

TURNING DIAGRAMS FLOOR PLANS FLOOR PLANS FLOOR PLANS A1.2 A2.0 **ELEVATIONS**

A2.1 **ELEVATIONS**

PERSPECTIVES A3.0

CIVIL SHEET INDEX


COVER SHEET TESC PLAN SITE IMPROVEMENT PLAN STANDARD NOTES STANDARD DETAILS STANDARD DETAILS STANDARD DETAILS

LANDSCAPE SHEET INDEX

L1.0 PLANTING PLAN

L2.0 SITE DETAILS

SURVEY TOPOGRAPHIC SURVEY INCLUDED

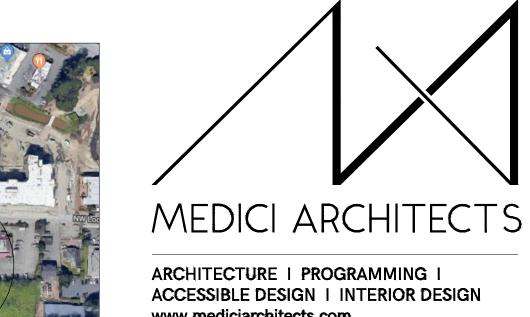

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11711 SE 8TH STREET, SUITE 100 BELLEVUE, WA 98005 TEL: (425) 453-9298

REGISTRATION:

DATE: INTAKE: **REVISIONS:** DATE:

PROJECT / CLIENT:

683 NW LOCUST STREET

DRM PROPERTIES MARK MCFADYEN 411 5TH ST ANACORTES, WA 98221 P: (206) 755-6041

JOB ADDRESS:

683 NW LOCUST AVE ISSAQUAH PARCEL # 884390-0530; 884390-0531

DRAWING NAME:

TITLE SHEET

Drawn By: JK, SJ Checked By: EB Owner Approval:


PHASE:

FEASIBILITY


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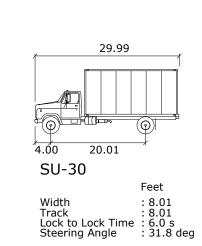
PROJECT No.: 2019 007 03-17-20 DATE:

A0.0

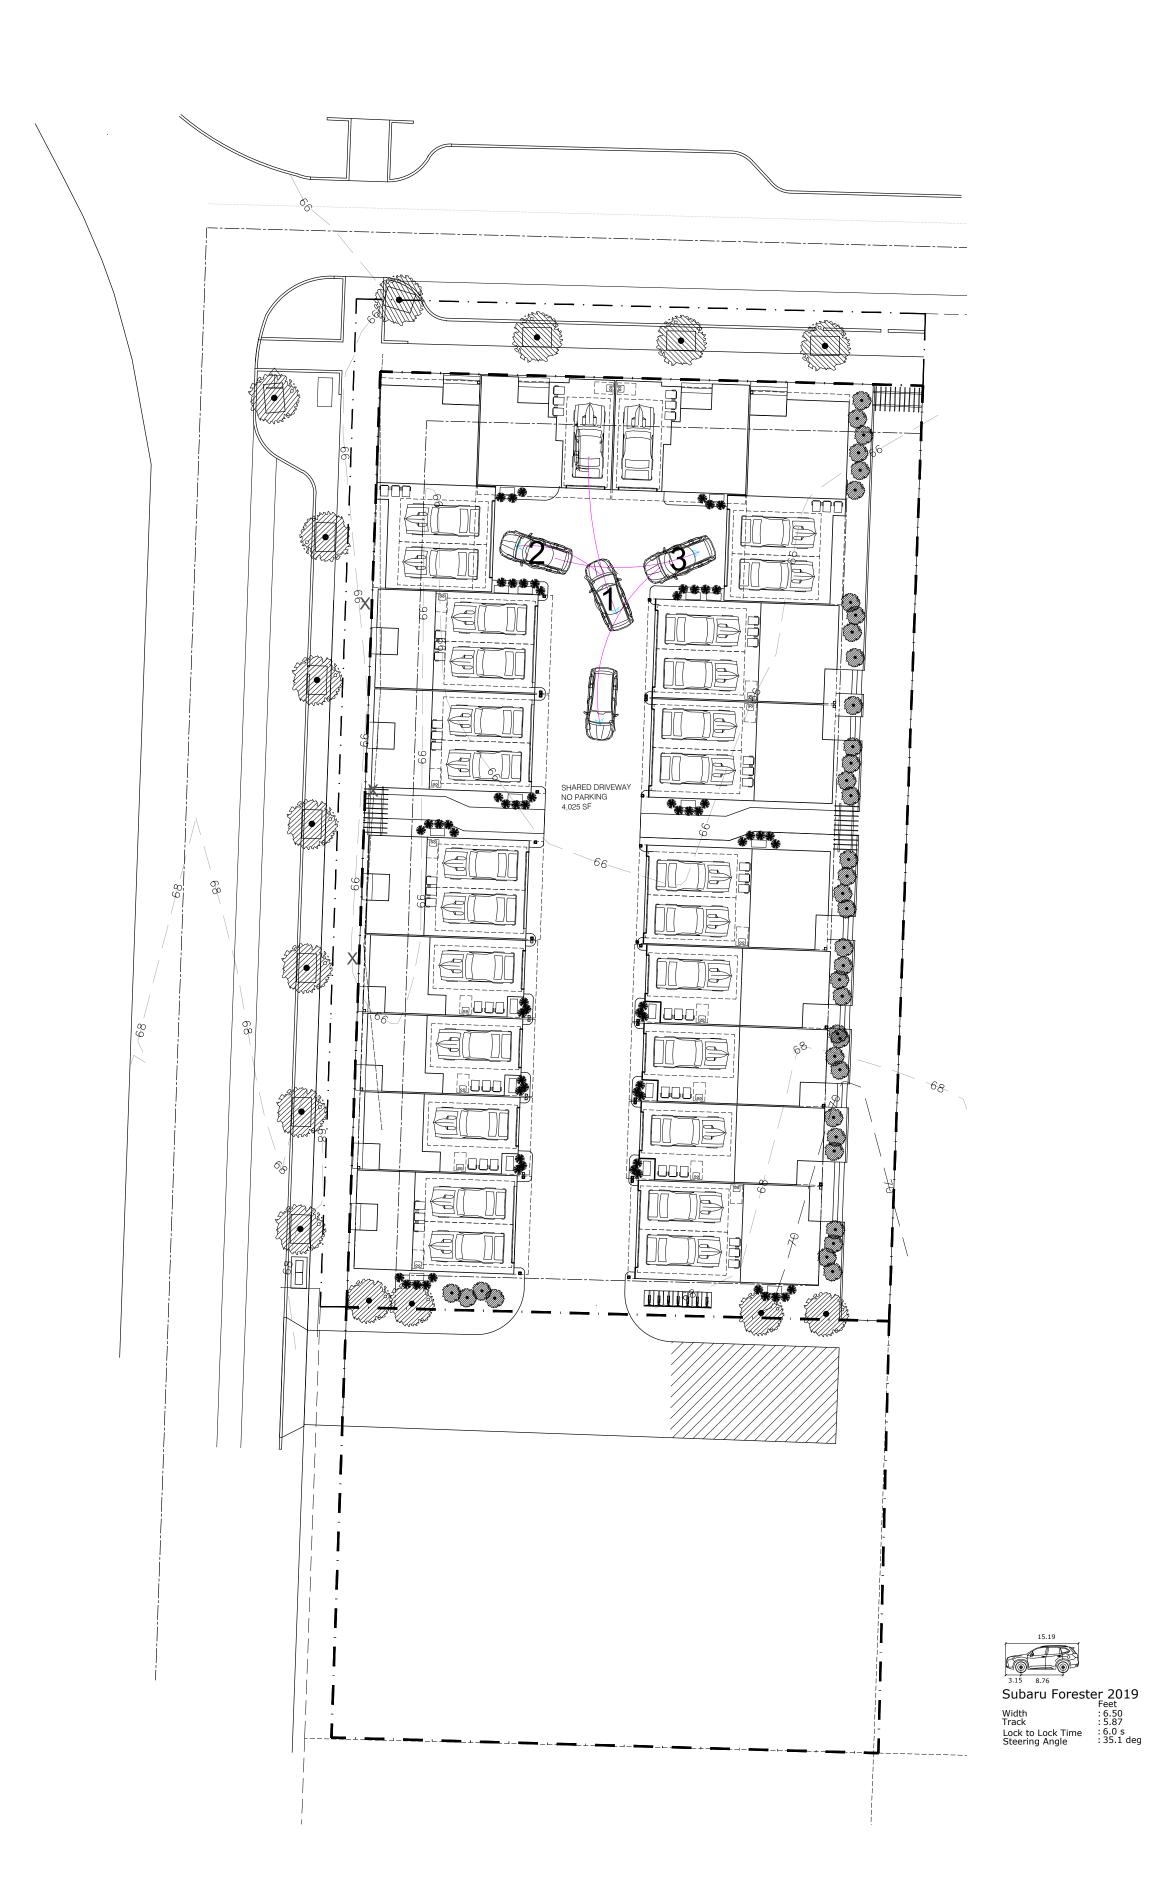

UNIT 9 OUT OF GARAGE
SCALE 1" = 20'



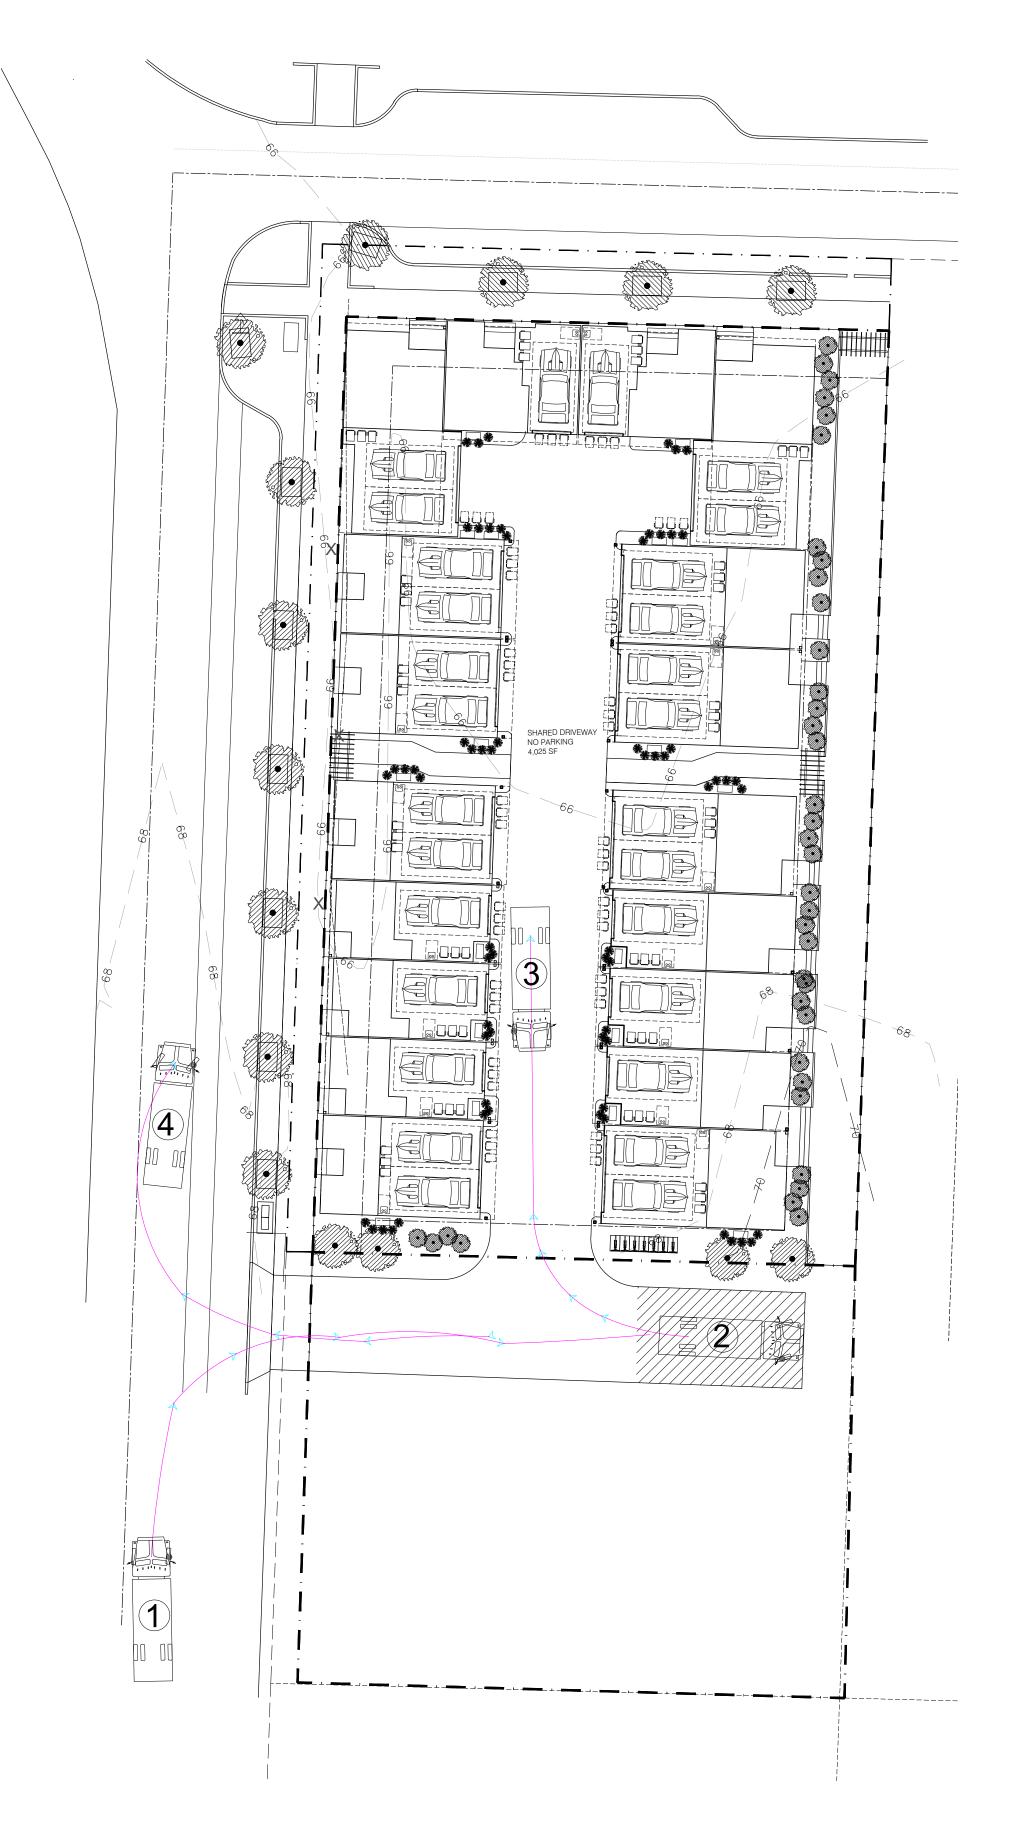

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REGISTRATION:

INTAKE: DATE: DATE: **REVISIONS**:

PROJECT / CLIENT:

683 NW LOCUST STREET

DRM PROPERTIES MARK MCFADYEN 411 5TH ST ANACORTES, WA 98221 P: (206) 755-6041

JOB ADDRESS:

683 NW LOCUST AVE ISSAQUAH PARCEL # 884390-0530; 884390-0531

DRAWING NAME:

TURNING DIAGRAMS

Drawn By: JK, SJ Checked By: EB Owner Approval:


PHASE:

FEASIBILITY


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GARBAGE TRUCK
SCALE 1" = 20'


PROJECT No.: 2019 007 DATE: 03-17-20

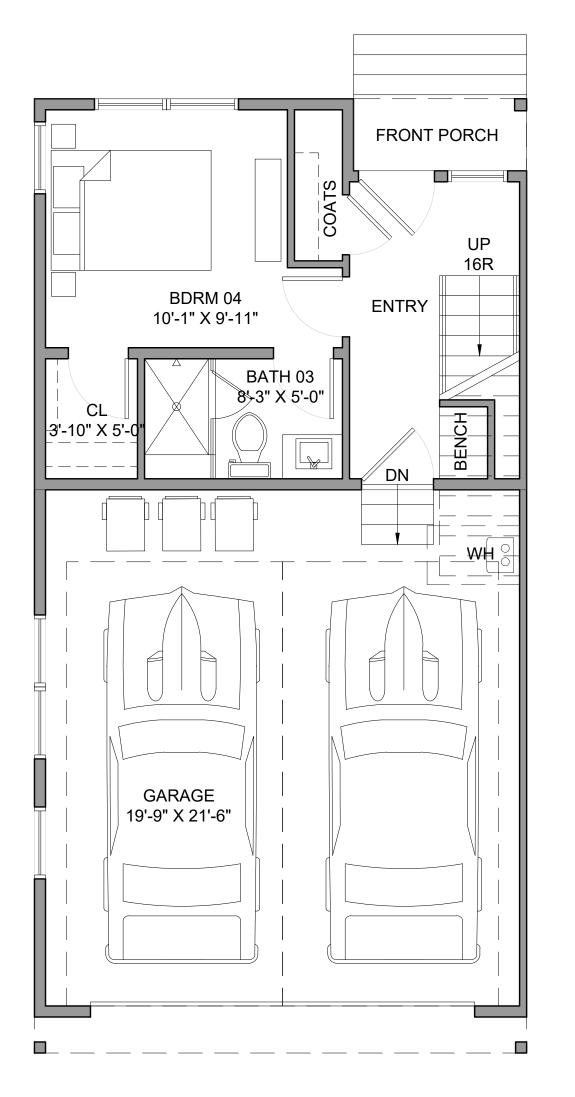


TYPE I | FIRST FLOOR

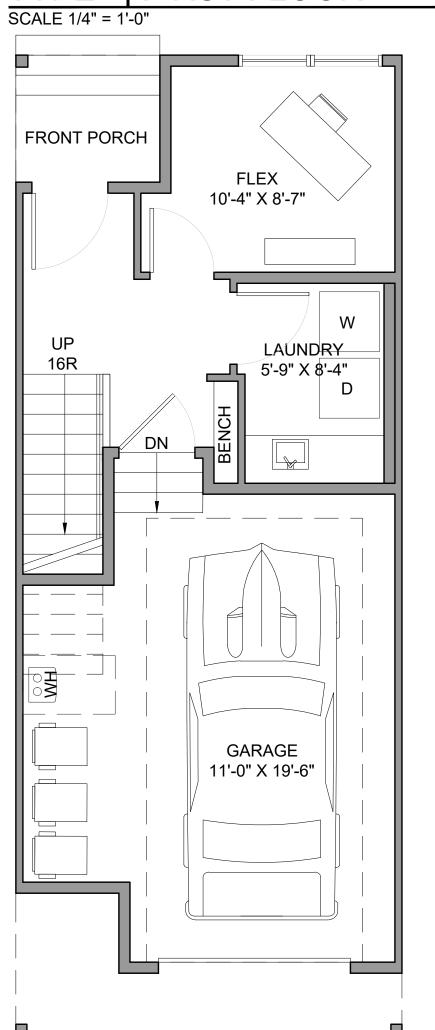


TYPE II | FIRST FLOOR SCALE 1/4" = 1'-0"

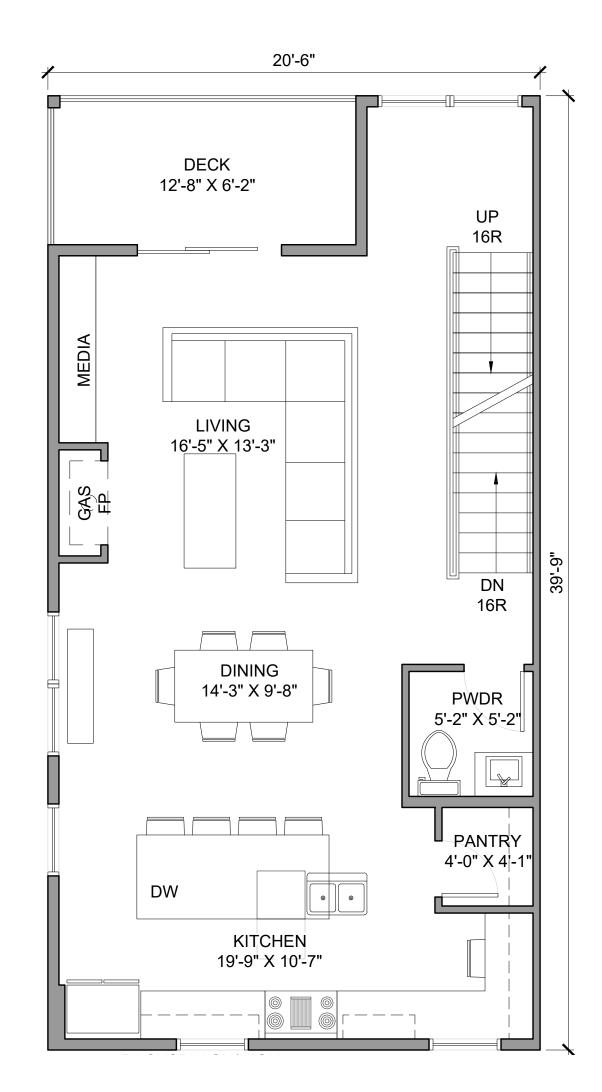


TYPE I | SECOND FLOOR

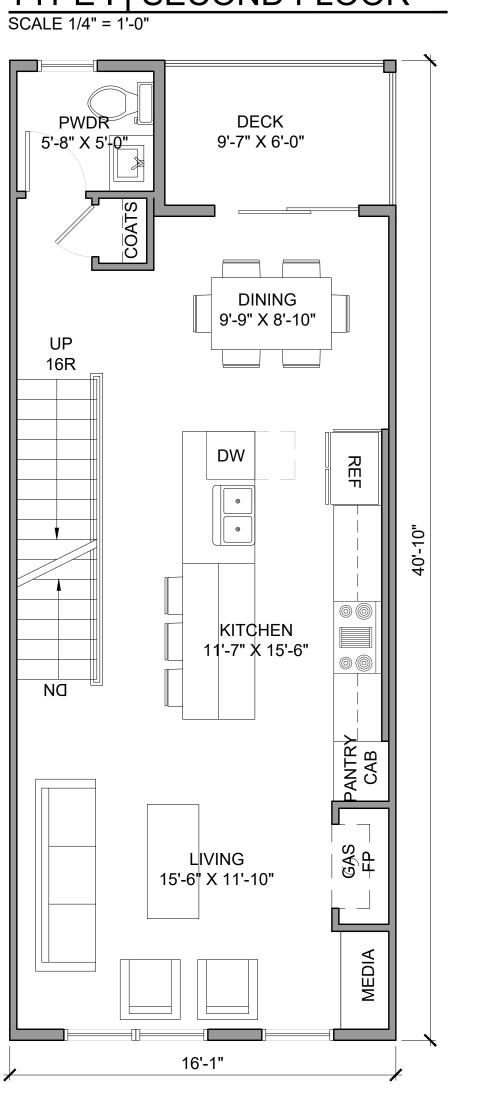

TYPE II | SECOND FLOOR SCALE 1/4" = 1'-0"

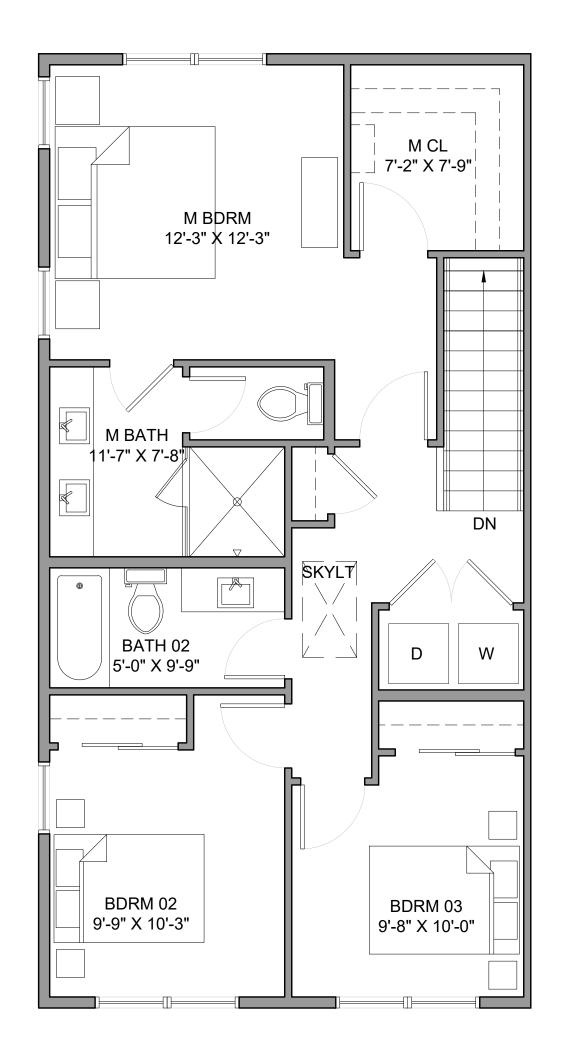

TYPE I | THIRD FLOOR

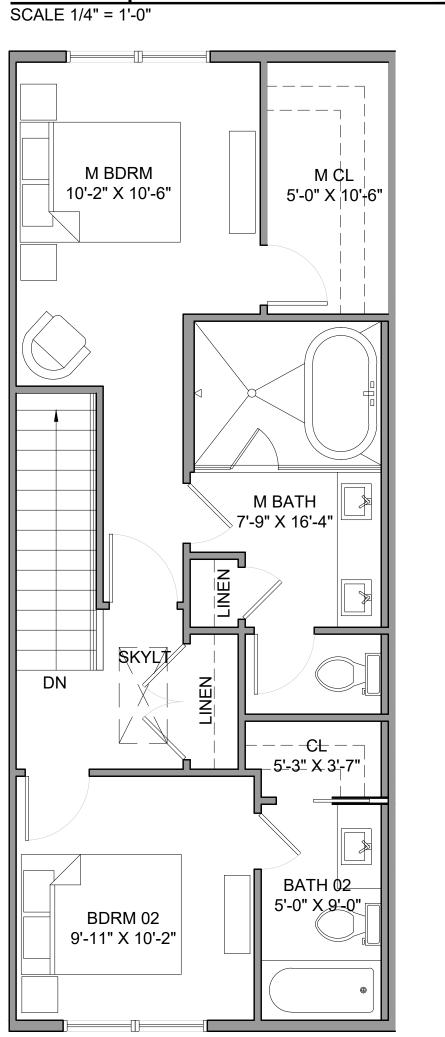

TYPE II | THIRD FLOOR SCALE 1/4" = 1'-0"



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5.	

PROJECT / CLIENT:

TYPE I UNIT FLOOR AREA:

TYPE II UNIT FLOOR AREA:

1ST FLOOR LIVING:

2ND FLOOR LIVING: 3RD FLOOR LIVING

TOTAL LIVING:

242 SF

560 SF

619 SF

1,421 SF

1ST FLOOR LIVING:

2ND FLOOR LIVING: 3RD FLOOR LIVING

TOTAL LIVING:

282 SF 690 SF 767 SF 1,739 SF

683 NW LOCUST STREET

DRM PROPERTIES MARK MCFADYEN 411 5TH ST ANACORTES, WA 98221 P: (206) 755-6041

JOB ADDRESS:

683 NW LOCUST AVE ISSAQUAH PARCEL # 884390-0530; 884390-0531

DRAWING NAME:

FLOOR PLANS UNIT TYPE I&II

Drawn By: JK, SJ Checked By: EB Owner Approval:

PHASE:

FEASIBILITY


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PROJECT No.: 2019 007

03-17-20

A1.0

DATE:

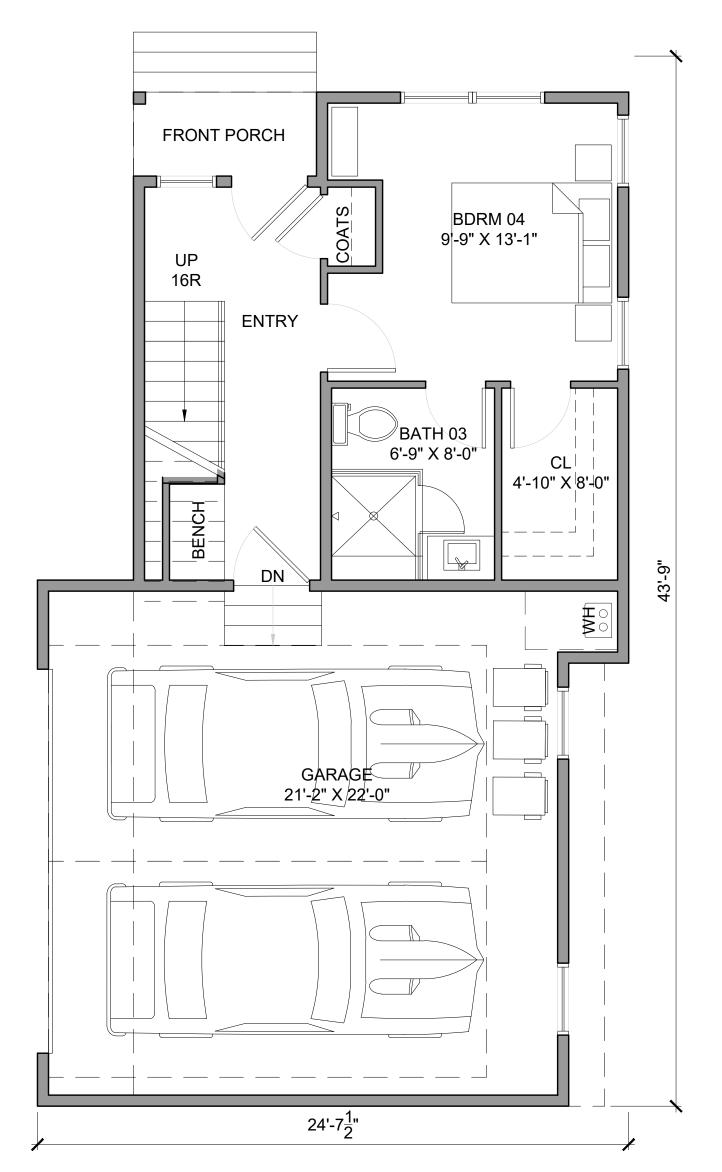

TYPE III | FIRST FLOOR

SCALE 1/4" = 1'-0"

27'-9<mark>1</mark>"

LAUNDRY

5'-10" X 8'-10"

TYPE IV | FIRST FLOOR

SCALE 1/4" = 1'-0"


GARAGE

10'-0" X 20'-0"

FRONT PORCH


FLEX

10'-7" X 8'-10"

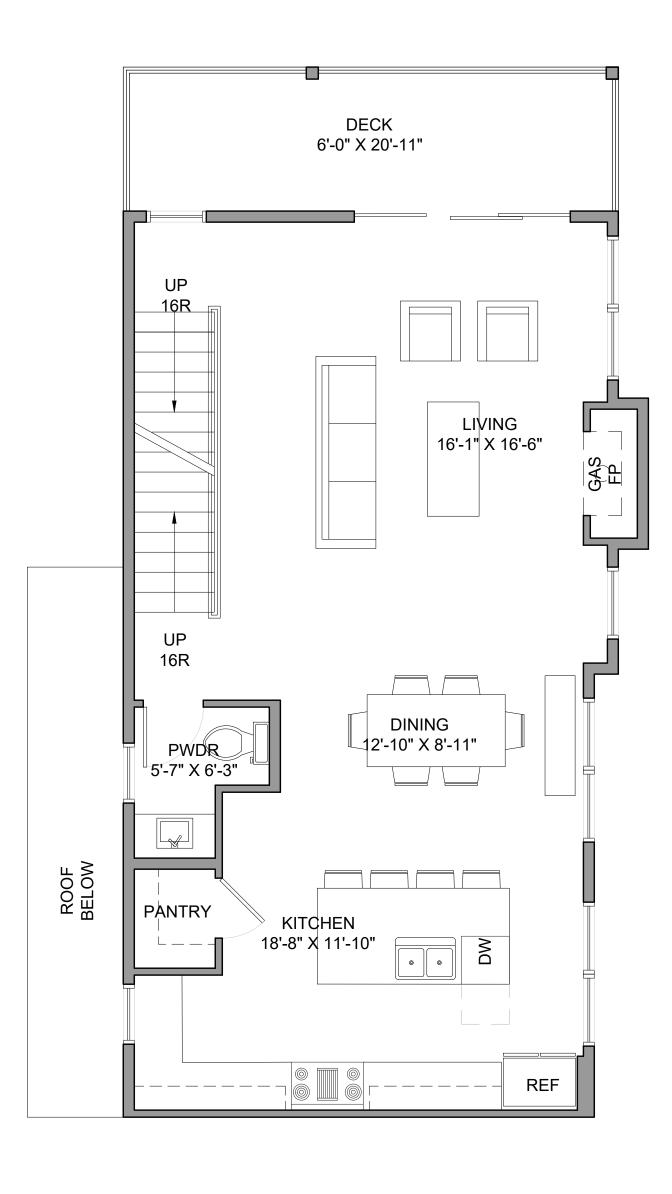


TYPE III | SECOND FLOOR

SCALE 1/4" = 1'-0"

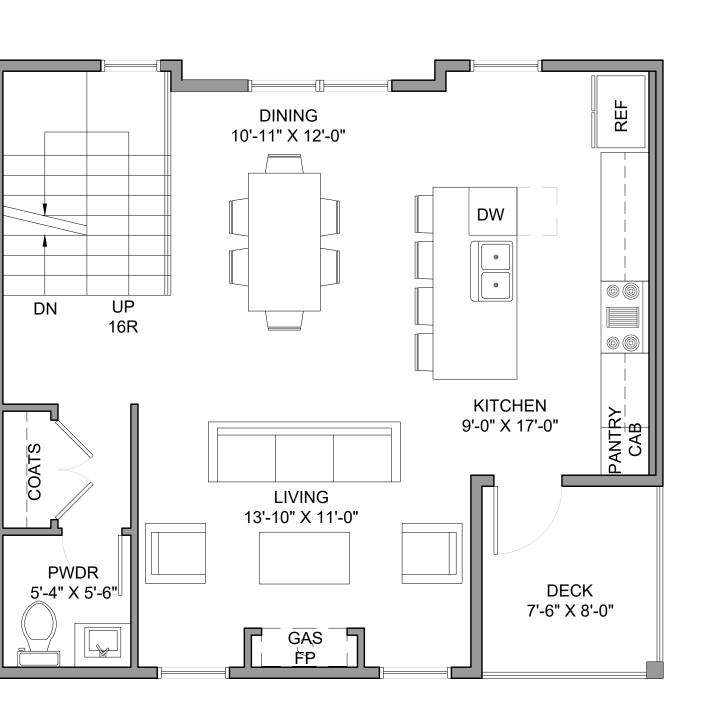


TYPE IV | SECOND FLOOR

SCALE 1/4" = 1'-0"

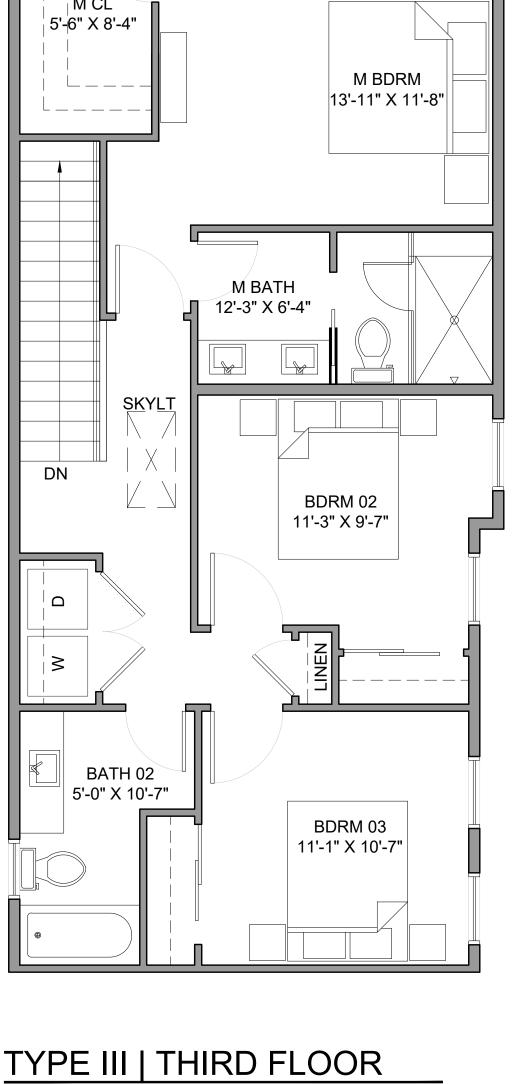


TYPE III | THIRD FLOOR

SCALE 1/4" = 1'-0"

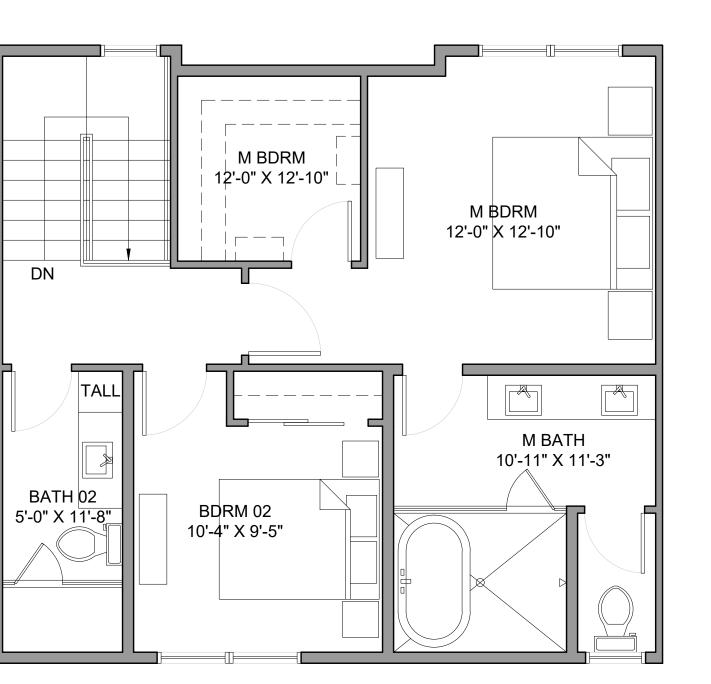

TYPE IV | THIRD FLOOR

SCALE 1/4" = 1'-0"

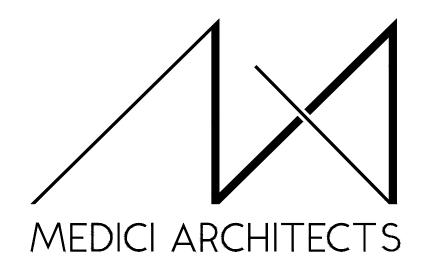

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TYPE III UNIT FLOOR AREA:

TYPE IV UNIT FLOOR AREA:

1ST FLOOR LIVING:

2ND FLOOR LIVING:

3RD FLOOR LIVING

TOTAL LIVING:

1ST FLOOR LIVING:

2ND FLOOR LIVING:

3RD FLOOR LIVING TOTAL LIVING:

360 SF

717 SF

1,906 SF

683 NW LOCUST STREET

DRM PROPERTIES MARK MCFADYEN 411 5TH ST ANACORTES, WA 98221 P: (206) 755-6041

JOB ADDRESS:

683 NW LOCUST AVE ISSAQUAH PARCEL # 884390-0530; 884390-0531

DRAWING NAME:

FLOOR PLANS UNIT TYPE III&IV

Drawn By: JK, SJ Checked By: EB Owner Approval:

PHASE:

FEASIBILITY

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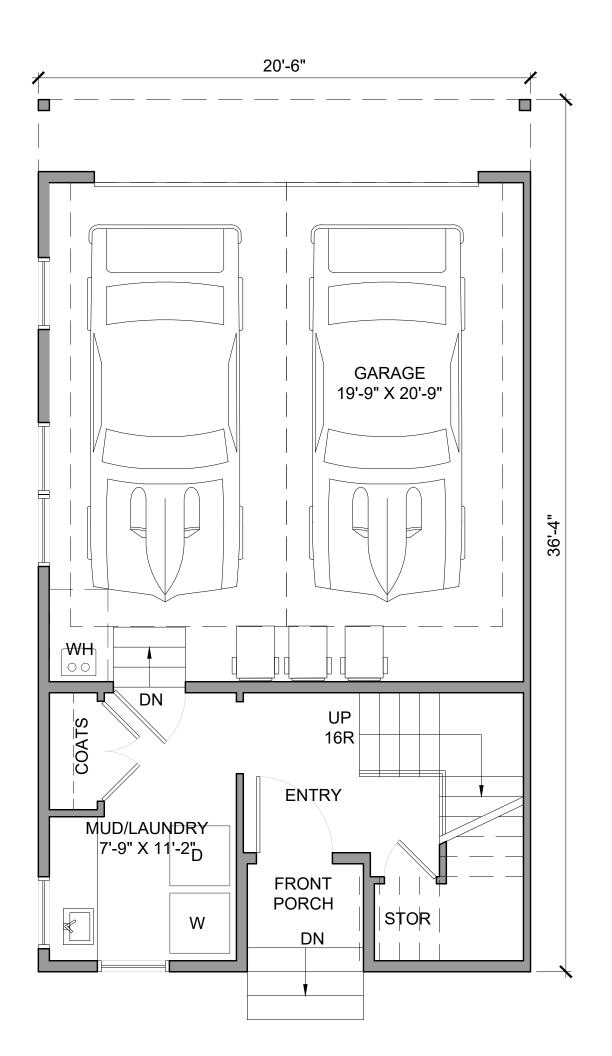
292 SF PROJECT No.: 2019 007 604 SF 667 SF


1,563 SF


DATE: 03-17-20


A1.1

PLOT SCALE: 1:1



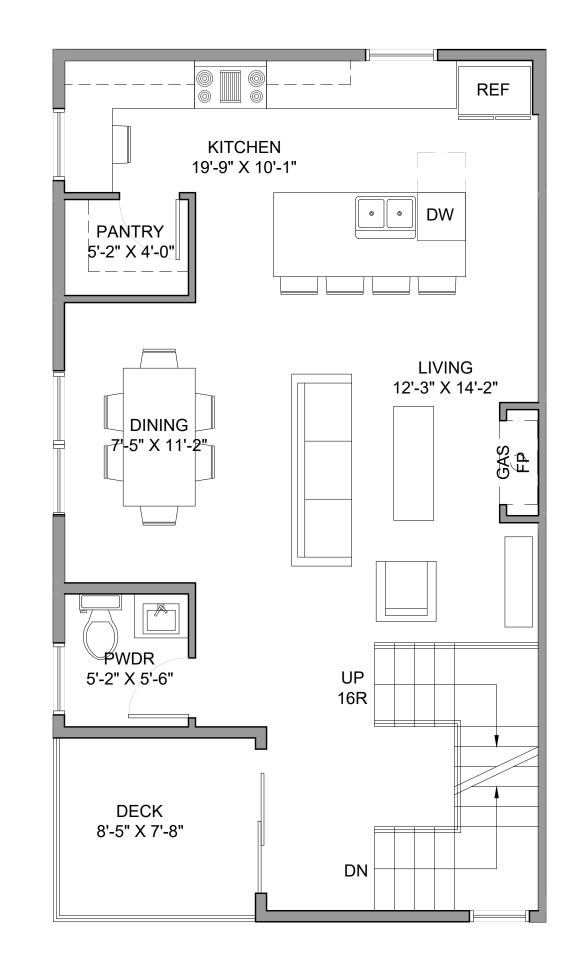

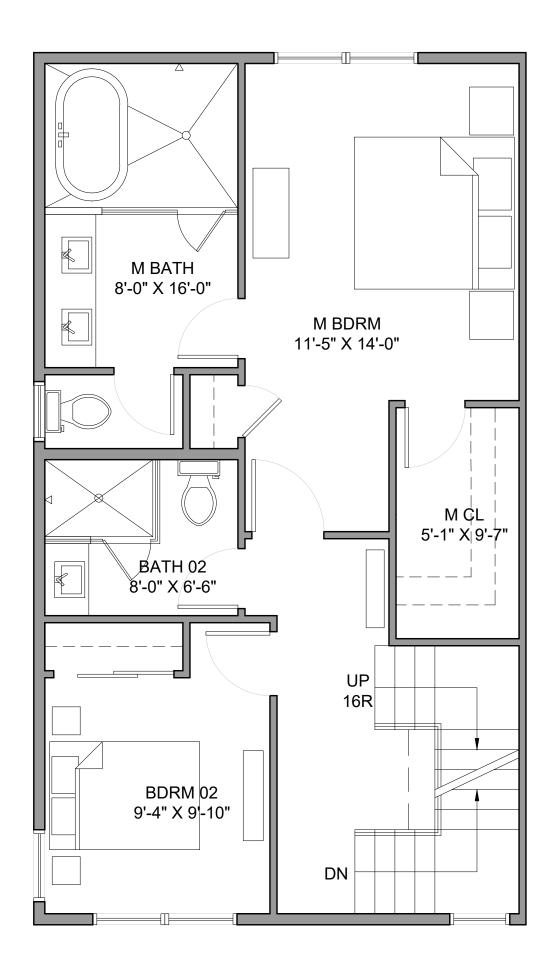

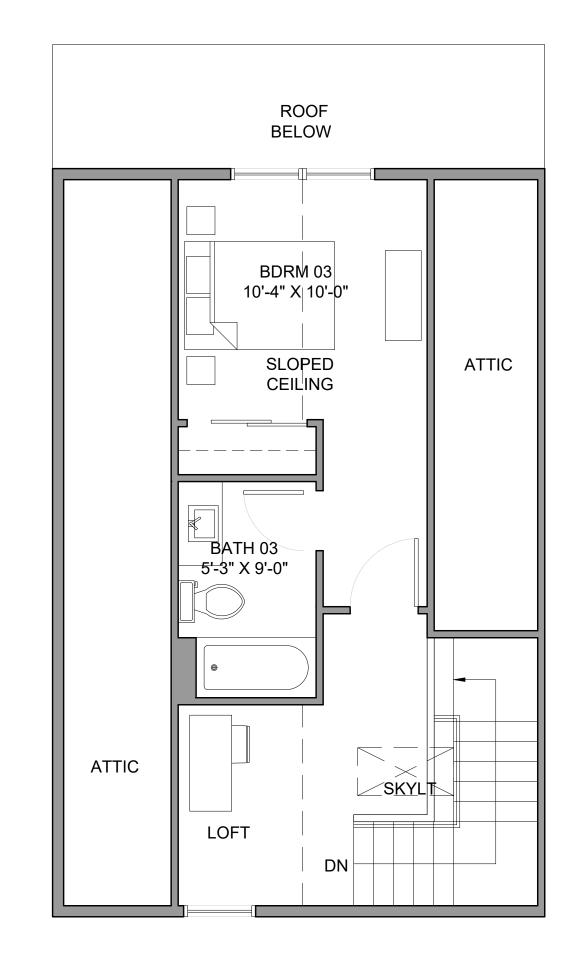




ARCHITECTURE I PROGRAMMING I ACCESSIBLE DESIGN | INTERIOR DESIGN www.mediciarchitects.com

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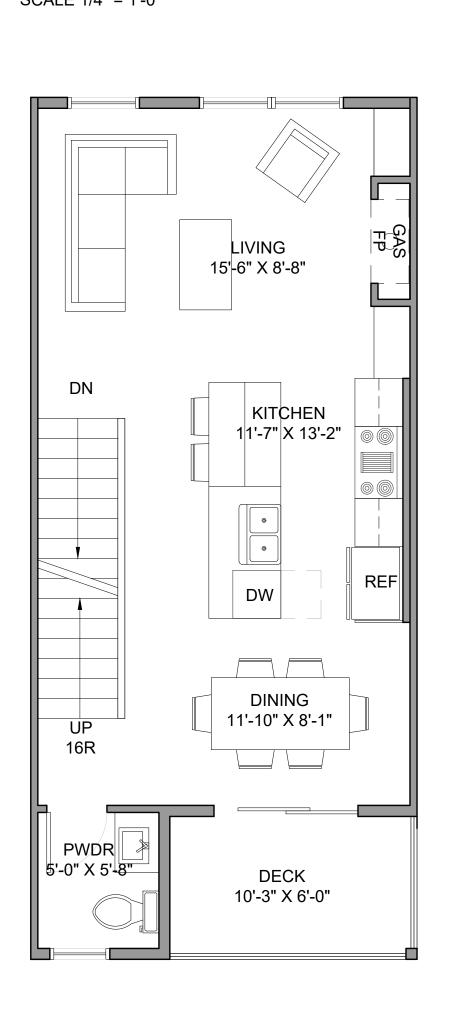





TYPE VI | FIRST FLOOR

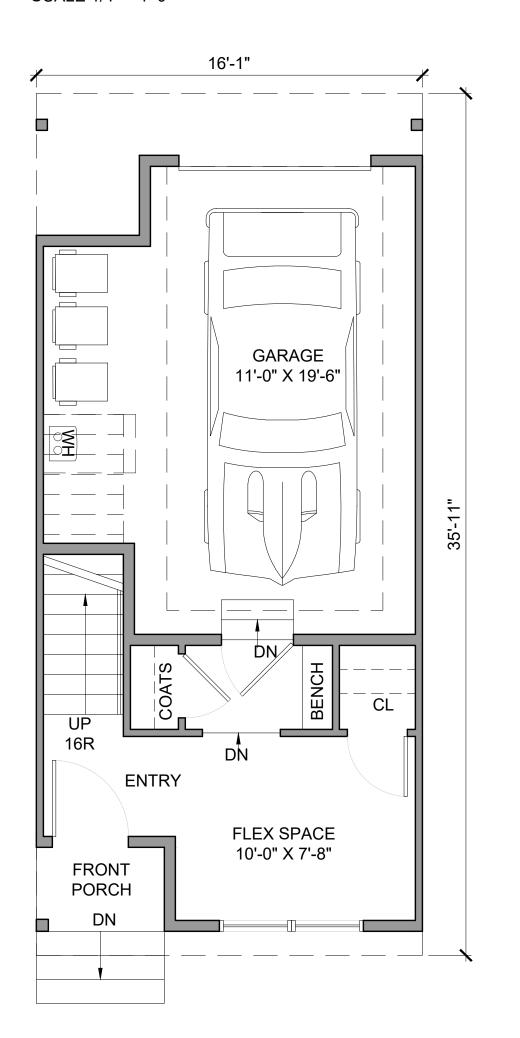SCALE 1/4" = 1'-0"






TYPE V | THIRD FLOOR SCALE 1/4" = 1'-0"

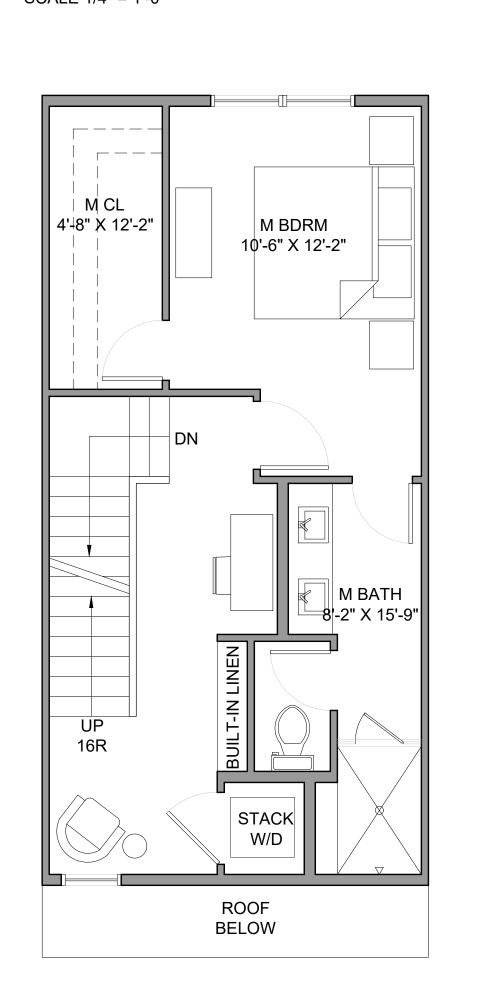

TYPE VI THIRD FLOOR

SCALE 1/4" = 1'-0"



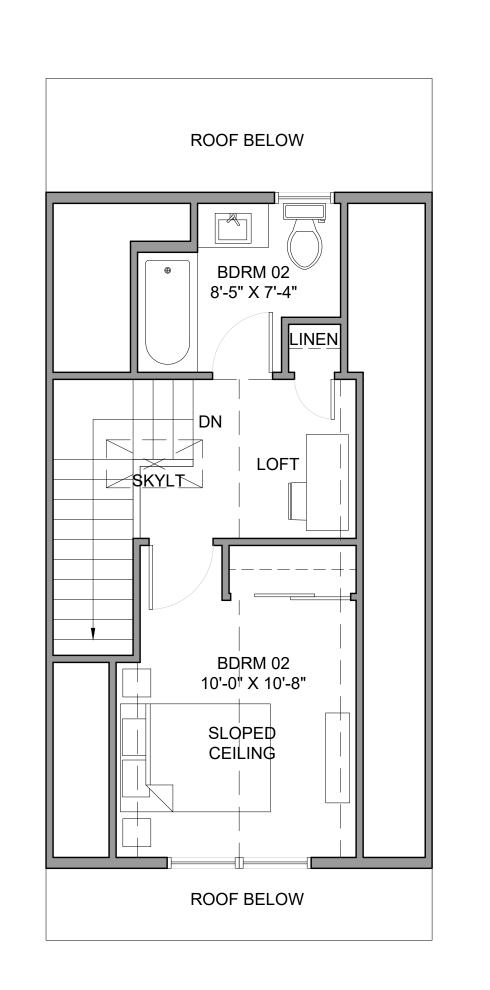

TYPE VI UNIT FLOOR AREA:

TYPE V UNIT FLOOR AREA:

1ST FLOOR LIVING:

2ND FLOOR LIVING:

3RD FLOOR LIVING:

4TH FLOOR LIVING:

TOTAL LIVING:

195 SF

635 SF

700 SF

365 SF

1,895 SF

1ST FLOOR LIVING:	171 SI
2ND FLOOR LIVING:	480 S
3RD FLOOR LIVING:	496 S
4TH FLOOR LIVING:	286 S
TOTAL LIVING:	1,537 S

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PROJECT / CLIENT:

683 NW LOCUST STREET

DRM PROPERTIES MARK MCFADYEN 411 5TH ST ANACORTES, WA 98221 P: (206) 755-6041

JOB ADDRESS:

683 NW LOCUST AVE ISSAQUAH PARCEL # 884390-0530; 884390-0531

DRAWING NAME:

FLOOR PLANS UNIT TYPE V&VI

Drawn By: JK, SJ Checked By: EB Owner Approval:

PHASE:

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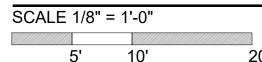
7TH AVE NW | WEST ELEVATIONS


SCALE 1/8" = 1'-0"

5' 10' 20



THROUGH BLOCK | EAST ELEVATIONS



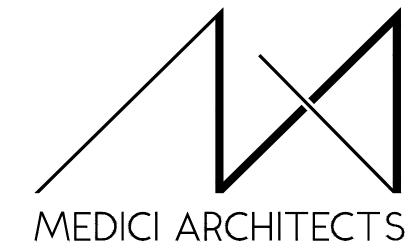

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683 NW LOCUST STREET

DRM PROPERTIES
MARK MCFADYEN
411 5TH ST
ANACORTES, WA 98221
P: (206) 755-6041

JOB ADDRESS:

683 NW LOCUST AVE ISSAQUAH PARCEL # 884390-0530; 884390-0531

DRAWING NAME:

ELEVATIONS

Drawn By: JK, SJ
Checked By: EB
Owner Approval:

PHASE:

FEASIBILITY


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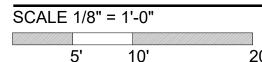



SHARED DRIVEWAY | SOUTH ELEVATIONS





NW LOCUST STREET | NORTH ELEVATIONS

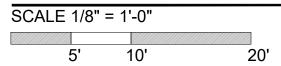

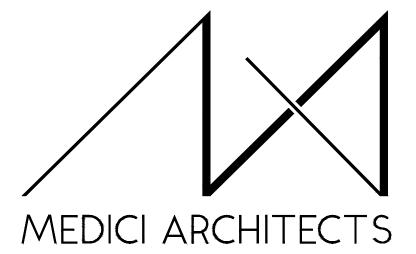

ARCHITECTURE | PROGRAMMING |
ACCESSIBLE DESIGN | INTERIOR DESIGN
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683 NW LOCUST STREET

DRM PROPERTIES
MARK MCFADYEN
411 5TH ST
ANACORTES, WA 98221
P: (206) 755-6041

JOB ADDRESS:

683 NW LOCUST AVE ISSAQUAH PARCEL # 884390-0530; 884390-0531

DRAWING NAME:

ELEVATIONS

Drawn By: JK, SJ
Checked By: EB
Owner Approval:

PHASE:

FEASIBILITY

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PROJECT No.: 2019 007

DATE: 03-17-20



NW VIEW



NE VIEW



SW VIEW



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PROJECT / CLIENT:

683 NW LOCUST STREET

DRM PROPERTIES
MARK MCFADYEN
411 5TH ST
ANACORTES, WA 98221
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JOB ADDRESS:

683 NW LOCUST AVE ISSAQUAH PARCEL # 884390-0530; 884390-0531

DRAWING NAME:

PERSPECTIVES

Drawn By: JK, SJ
Checked By: EB
Owner Approval:

PHASE:

FEASIBILITY


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PROJECT No.: 2019 007

DATE: 03-17-20

03-17-20

A3.0

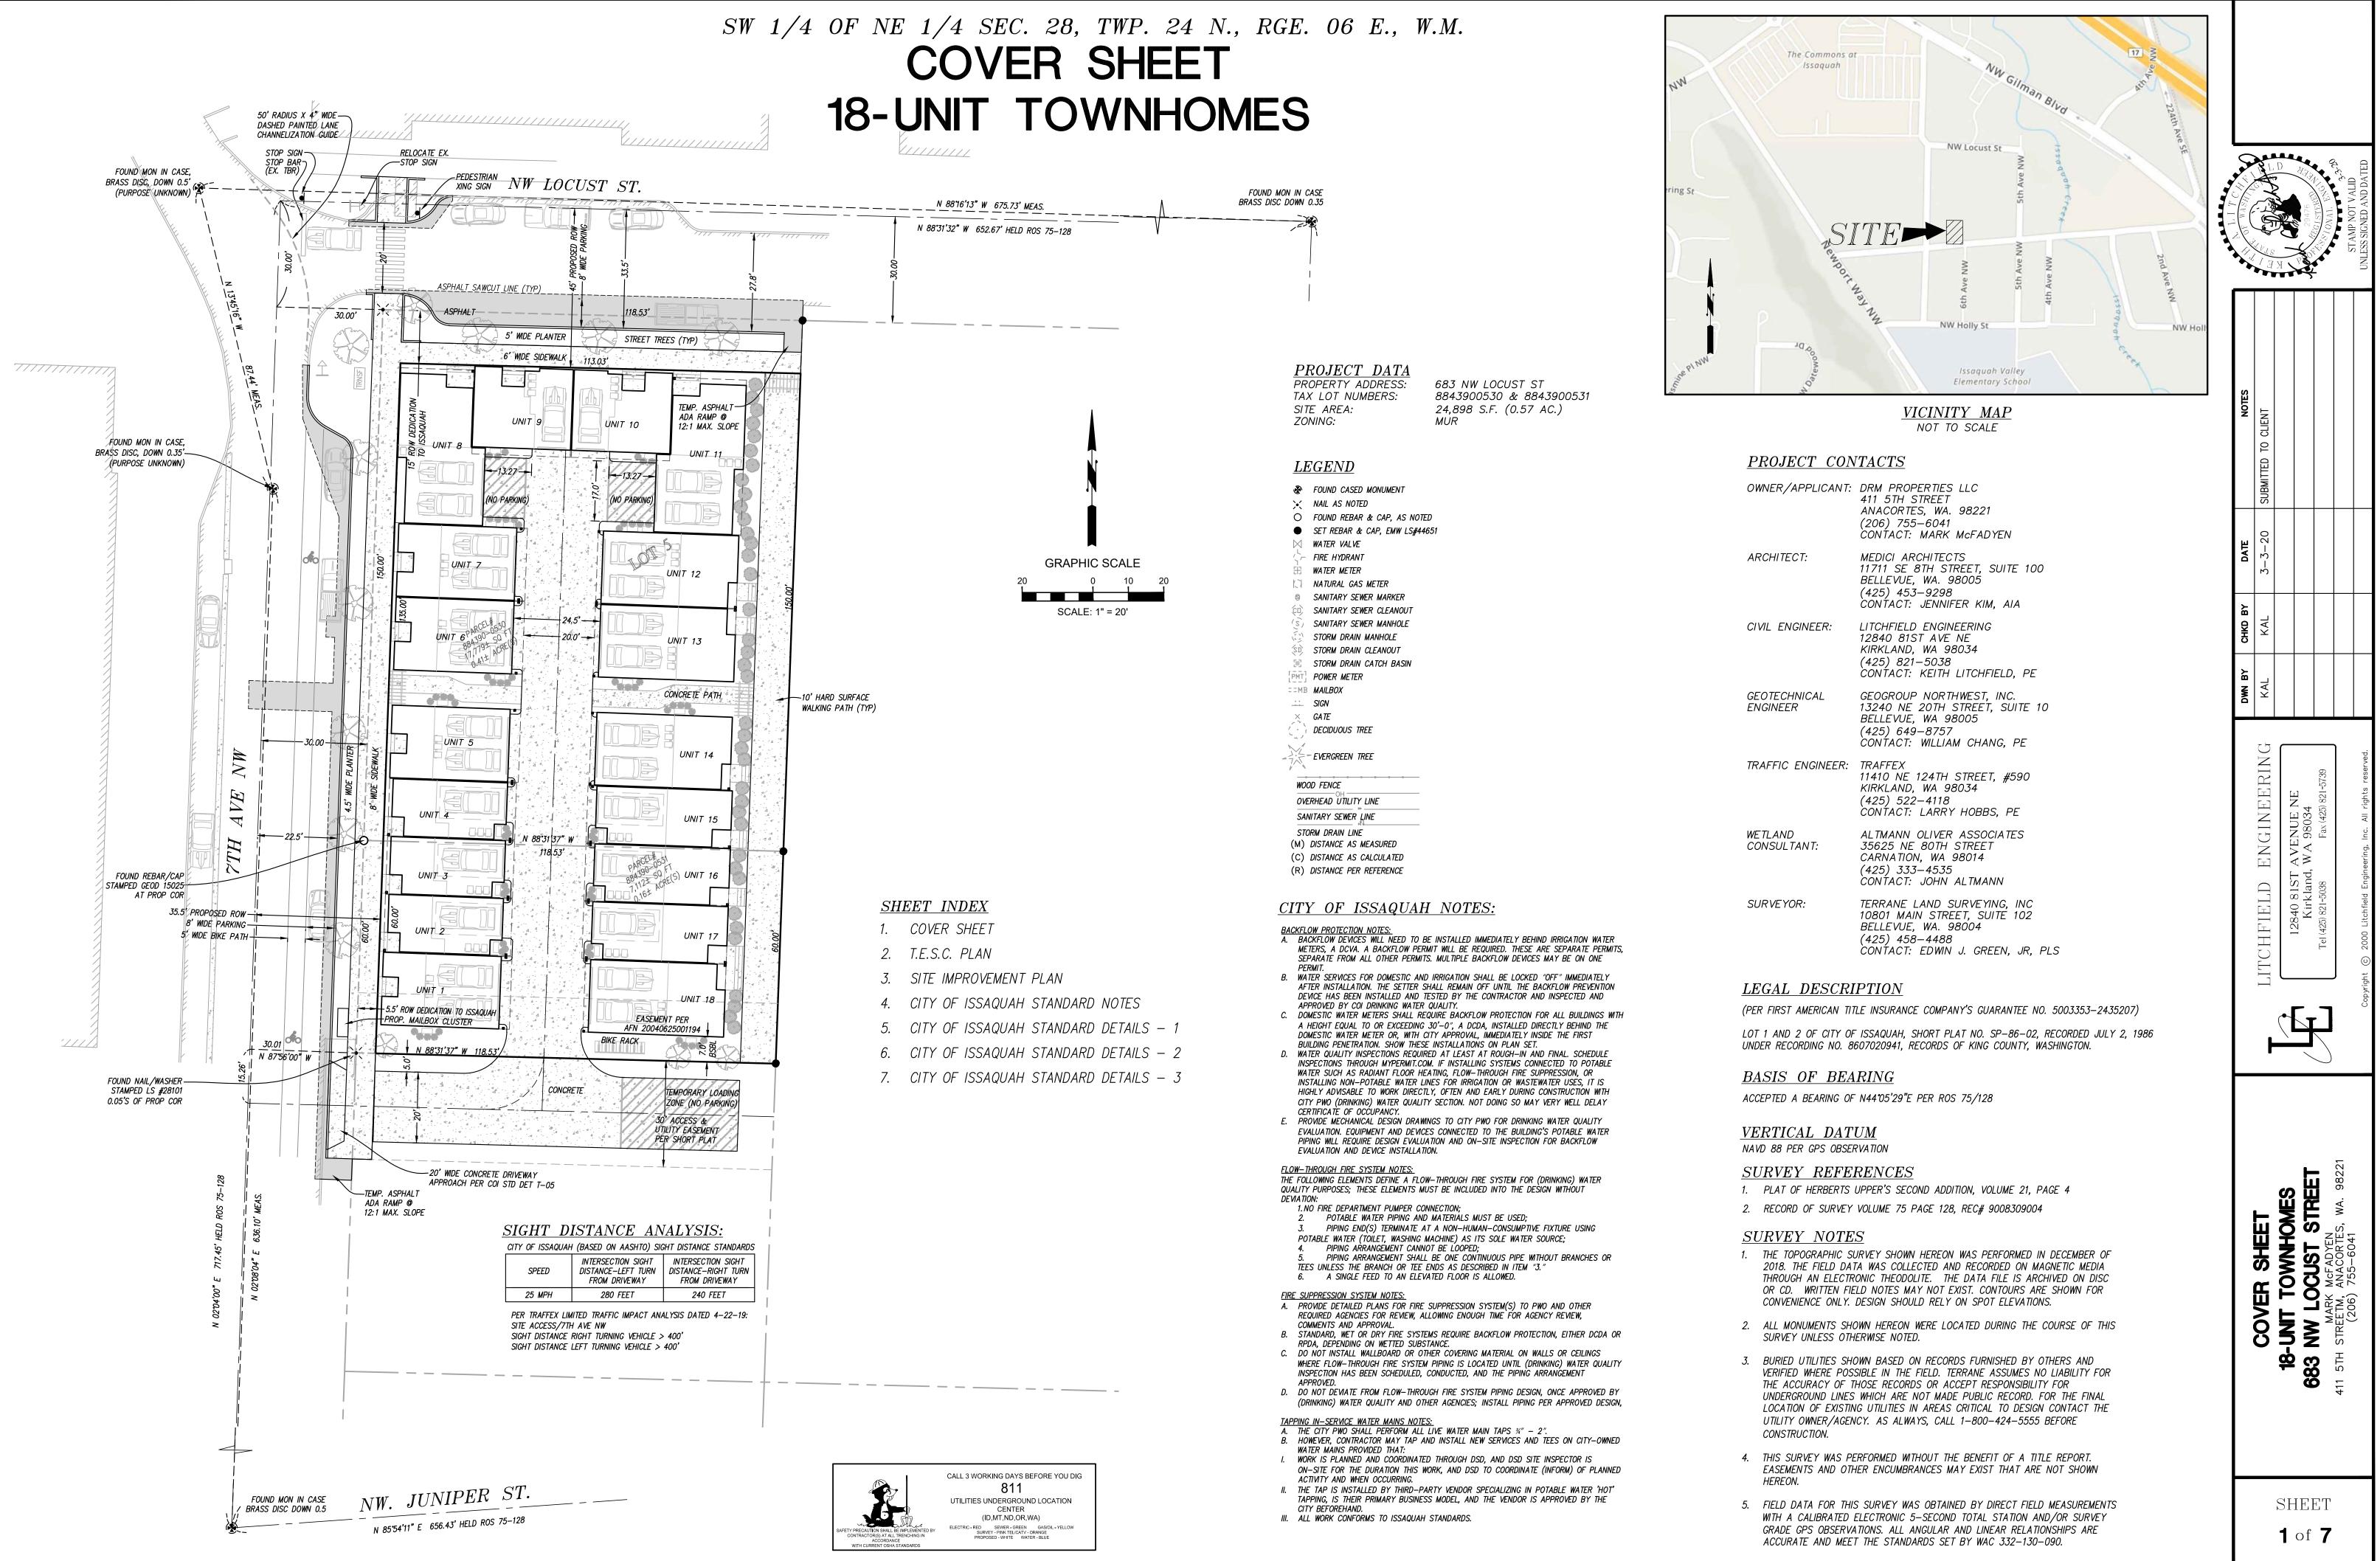

EROSION & SEDIMENT CONTROL NOTES

- 1. THE APPROVED CONSTRUCTION SEQUENCE SHALL BE AS FOLLOWS:
- A. CONDUCT PRE—CONSTRUCTION MEETING.
 B. FLAG OR FENCE CLEARING LIMITS.
- C. POST SIGN WITH NAME AND PHONE NUMBER OF TESC SUPERVISOR.
- D. INSTALL CATCH BASIN PROTECTION IF REQUIRED.
- E. GRADE AND INSTALL CONSTRUCTION ENTRANCE(S).
 F. INSTALL PERIMETER PROTECTION (SILT FENCE, BRUSH BARRIER, ETC.).
- G. CONSTRUCT SEDIMENT PONDS AND TRAPS. H. GRADE AND STABILIZE CONSTRUCTION ROADS.
- I. CONSTRUCT SURFACE WATER CONTROLS (INTERCEPTOR DIKES, PIPE SLOPE DRAINS, ETC.) SIMULTANEOUSLY WITH CLEARING AND GRADING FOR PROJECT DEVELOPMENT.
- J. MAINTAIN EROSION CONTROL MEASURE IN ACCORDANCE WITH CITY OF
- ISSAQUAH STANDARDS AND MANUFACTURER'S RECOMMENDATIONS.
 K. RELOCATE EROSION CONTROL MEASURES OR INSTALL NEW MEASURES SO
- THAT AS SITE CONDITIONS CHANGE, THE EROSION AND SEDIMENT CONTROL IS ALWAYS IN ACCORDANCE WITH THE CITY TESC MINIMUM REQUIREMENTS.

 L. COVER ALL AREAS WITHIN THE SPECIFIED TIME FRAME WITH STRAW, WOOD
- FIBER MULCH, COMPOST, PLASTIC SHEETING, CRUSHED ROCK OR EQUIVALENT.
 M. STABILIZE ALL AREAS THAT REACH FINAL GRADE WITHIN 7 DAYS.
- M. STABILIZE ALL AREAS THAT REACH FINAL GRADE WITHIN 7 DAYS.
 N. SEED OR SOD ANY AREAS TO REMAIN UNWORKED FOR MORE THAN 30 DAYS.
 O. UPON COMPLETION OF THE PROJECT, ALL DISTURBED AREAS MUST BE STABILIZED AND BEST MANAGEMENT PRACTICES REMOVED IF APPROPRIATE.
- 2. ALL WORK AND MATERIALS SHALL BE IN ACCORDANCE WITH CITY OF ISSAQUAH STANDARDS AND SPECIFICATIONS.
- 3. THE BOUNDARIES OF THE CLEARING LIMITS SHOWN ON THIS PLAN SHALL BE SET BY SURVEY AND CLEARLY FLAGGED IN THE FIELD BY A CLEARING CONTROL FENCE PRIOR TO CONSTRUCTION. DURING THE CONSTRUCTION PERIOD, NO DISTURBANCE OR REMOVAL OF ANY GROUND COVER BEYOND THE FLAGGED CLEARING LIMITS SHALL BE PERMITTED. THE FLAGGING SHALL BE MAINTAINED BY THE PERMITTEE/CONTRACTOR FOR THE DURATION OF CONSTRUCTION.
- 4. APPROVAL OF THIS EROSION/SEDIMENTATION CONTROL (ESC) PLAN DOES NOT CONSTITUTE AN APPROVAL OF PERMANENT ROAD OR DRAINAGE DESIGN (E.G., SIZE AND LOCATION OF ROADS, PIPES, RESTRICTORS, CHANNELS, RETENTION FACILITIES, UTILITIES, ETC.).
- 5. THE IMPLEMENTATION OF THIS ESC PLAN AND THE CONSTRUCTION, MAINTENANCE, REPLACEMENT, AND UPGRADING OF THESE ESC FACILITIES IS THE RESPONSIBILITY OF THE PERMITTEE/CONTRACTOR UNTIL ALL CONSTRUCTION IS APPROVED.
- 6. A COPY OF THE APPROVED ESC PLANS MUST BE ON THE JOB SITE WHENEVER CONSTRUCTION IS IN PROGRESS.
- 7. THE ESC FACILITIES SHOWN ON THIS PLAN MUST BE CONSTRUCTED PRIOR TO OR IN CONJUNCTION WITH ALL CLEARING AND GRADING ACTIVITIES IN SUCH A MANNER AS TO ENSURE THAT SEDIMENT—LADEN WATER DOES NOT ENTER THE DRAINAGE SYSTEM OR VIOLATE APPLICABLE WATER STANDARDS. WHEREVER POSSIBLE, MAINTAIN NATURAL VEGETATION FOR SILT CONTROL.
- 8. THE ESC FACILITIES SHALL BE CONSTRUCTED IN ACCORDANCE WITH THE DETAILS ON THE APPROVED PLANS. LOCATIONS MAY BE MOVED TO SUIT FIELD CONDITIONS, SUBJECT TO APPROVAL BY THE ENGINEER AND THE CITY OF ISSAQUAH INSPECTOR.
- 9. THE ESC FACILITIES SHOWN ON THIS PLAN ARE THE MINIMUM REQUIREMENTS FOR ANTICIPATED SITE CONDITIONS. DURING THE CONSTRUCTION PERIOD, THESE ESC FACILITIES SHALL BE UPGRADED (E.G., ADDITIONAL SUMPS, RELOCATION OF DITCHES AND SILT FENCES, ETC.) AS NEEDED FOR UNEXPECTED STORM EVENTS. ADDITIONALLY, MORE ESC FACILITIES MAY BE REQUIRED TO ENSURE COMPLETE SILTATION CONTROL. THEREFORE, DURING THE COURSE OF CONSTRUCTION IT SHALL BE THE OBLIGATION AND RESPONSIBILITY OF THE CONTRACTOR TO ADDRESS ANY NEW CONDITIONS THAT MAY BE CREATED BY HIS ACTIVITIES AND TO PROVIDE ADDITIONAL FACILITIES OVER AND ABOVE THE MINIMUM REQUIREMENTS AS MAY BE
- 10. THE ESC FACILITIES SHALL BE INSPECTED BY THE PERMITTEE/CONTRACTOR DAILY DURING NON—RAINFALL PERIODS, EVERY HOUR (DAYLIGHT) DURING A RAINFALL EVENT, AND AT THE END OF EVERY RAINFALL, AND MAINTAINED AS NECESSARY TO ENSURE THEIR CONTINUED FUNCTIONING. IN ADDITION, TEMPORARY SILTATION PONDS AND ALL TEMPORARY SILTATION CONTROLS SHALL BE MAINTAINED IN A SATISFACTORY CONDITION UNTIL SUCH TIME THAT CLEARING AND/OR CONSTRUCTION IS COMPLETED, PERMANENT DRAINAGE FACILITIES ARE OPERATIONAL, AND THE POTENTIAL FOR EROSION HAS PASSED. WRITTEN RECORDS SHALL BE KEPT DOCUMENTING THE REVIEWS OF THE ESC FACILITIES.
- 11. THE ESC FACILITIES ON INACTIVE SITES SHALL BE INSPECTED AND MAINTAINED A MINIMUM OF ONCE A MONTH OR WITHIN 48 HOURS FOLLOWING A STORM EVENT.
- 12. STABILIZED CONSTRUCTION ENTRANCES SHALL BE INSTALLED AT THE BEGINNING OF CONSTRUCTION AND MAINTAINED FOR THE DURATION OF THE PROJECT. ADDITIONAL MEASURES, SUCH AS WASH PADS, MAY BE REQUIRED TO ENSURE THAT ALL PAVED AREAS ARE KEPT CLEAN FOR THE DURATION OF THE PROJECT.
- 13. ALL DENUDED SOILS MUST BE STABILIZED WITH AN APPROVED TESC METHOD (E.G. SEEDING, MULCHING, PLASTIC COVERING, CRUSHED ROCK) WITHIN THE FOLLOWING TIMELINES:
 - MAY 1 TO SEPTEMBER 30 SOILS MUST BE STABILIZED WITHIN 7 DAYS OF GRADING.

 TO SEPTEMBER 30 SOILS MUST BE STABILIZED WITHIN 2
 - OCTOBER 1 TO APRIL 30 SOILS MUST BE STABILIZED WITHIN 2 DAYS OF GRADING.
 STABILIZE SOILS AT THE END OF THE WORKDAY PRIOR TO A
- WEEKEND, HOLIDAY, OR PREDICTED RAIN EVENT.

 14. WHERE SEEDING FOR TEMPORARY EROSION CONTROL IS REQUIRED, FAST
- GERMINATING GRASSES SHALL BE APPLIED AT AN APPROPRIATE RATE (EXAMPLE: ANNUAL OR PERENNIAL RYE APPLIED AT APPROXIMATELY 80 POUNDS PER ACRE).
- 15. WHERE STRAW MULCH IS REQUIRED FOR TEMPORARY EROSION CONTROL, IT SHALL BE APPLIED AT A MINIMUM THICKNESS OF 2".
- 16. ALL LOTS ADJOINING OR HAVING ANY NATIVE GROWTH PROTECTION
 EASEMENTS (NGPE) SHALL HAVE A 6' HIGH TEMPORARY CONSTRUCTION
 FENCE (CHAIN LINK WITH PIER BLOCKS) SEPARATING THE LOT (OR
 BUILDABLE PORTIONS OF THE LOT) FROM THE AREA RESTRICTED BY THE
 NGPE AND SHALL BE INSTALLED PRIOR TO ANY GRADING OR CLEARING AND
 REMAIN IN PLACE UNTIL THE PLANNING DEPARTMENT AUTHORIZES REMOVAL.


- 17. CLEARING LIMITS SHALL BE DELINEATED WITH A CLEARING CONTROL FENCE. THE CLEARING CONTROL FENCE SHALL CONSIST OF A 6-FT. HIGH CHAIN LINK FENCE ADJACENT THE DRIP LINE OF TREES TO BE SAVED, WETLAND OR STREAM BUFFERS, AND SENSITIVE SLOPES. CLEARING CONTROL FENCES ALONG WETLAND OR STREAM BUFFERS OR UPSLOPE OF SENSITIVE SLOPES SHALL BE ACCOMPANIED BY AN EROSION CONTROL FENCE. IF APPROVED BY THE CITY, A FOUR-FOOT HIGH ORANGE MESH CLEARING CONTROL FENCE MAY BE USED TO DELINEATE CLEARING LIMITS IN ALL OTHER AREAS.
- 18. OFF—SITE STREETS MUST BE KEPT CLEAN AT ALL TIMES. IF DIRT IS DEPOSITED ON THE PUBLIC STREET SYSTEM, THE STREET SHALL BE IMMEDIATELY CLEANED WITH POWER SWEEPER OR OTHER EQUIPMENT. ALL VEHICLES SHALL LEAVE THE SITE BY WAY OF THE CONSTRUCTION ENTRANCE AND SHALL BE CLEANED OF ALL DIRT THAT WOULD BE DEPOSITED ON THE PUBLIC STREETS.
- 19. ROCK FOR EROSION PROTECTION OF ROADWAY DITCHES, WHERE REQUIRED, MUST BE OF SOUND QUARRY ROCK, PLACED TO A DEPTH OF 1' AND MUST MEET THE FOLLOWING SPECIFICATIONS: 4"-8" ROCK/40%-70% PASSING; 2"-4" ROCK/30%-40% PASSING; AND 1"-2" ROCK/10%-20% PASSING. RECYCLED CONCRETE SHALL NOT BE USED FOR CONSTRUCTION ENTRANCE OR TEMPORARY STABILIZATION ELSEWHERE ON THE SITE.
- 20. IF ANY PART(S) OF THE CLEARING LIMIT BOUNDARY OR TEMPORARY EROSION/SEDIMENTATION CONTROL PLAN IS/ARE DAMAGED, IT SHALL BE REPAIRED IMMEDIATELY.
- 21. ALL PROPERTIES ADJACENT TO THE PROJECT SITE SHALL BE PROTECTED FROM SEDIMENT DEPOSITION AND RUNOFF.
- 22. AT NO TIME SHALL MORE THAN 1' OF SEDIMENT BE ALLOWED TO ACCUMULATE WITHIN A CATCH BASIN. ALL CATCH BASINS AND CONVEYANCE LINES SHALL BE CLEANED PRIOR TO PAVING. THE CLEANING OPERATION SHALL NOT FLUSH SEDIMENT—LADEN WATER INTO THE DOWNSTREAM SYSTEM.
- 23. ANY PERMANENT RETENTION/DETENTION FACILITY USED AS A TEMPORARY SETTLING BASIN SHALL BE MODIFIED WITH THE NECESSARY EROSION CONTROL MEASURES AND SHALL PROVIDE ADEQUATE STORAGE CAPACITY. IF THE PERMANENT FACILITY IS TO FUNCTION ULTIMATELY AS AN INFILTRATION OR DISPERSION SYSTEM, THE FACILITY SHALL NOT BE USED AS A TEMPORARY SETTLING BASIN. NO UNDERGROUND DETENTION TANK, DETENTION VAULT, OR SYSTEM WHICH BACKS UNDER OR INTO A POND SHALL BE USED AS A TEMPORARY SETTLING BASIN.
- 24. ALL EROSION/SEDIMENTATION CONTROL PONDS WITH A DEAD STORAGE DEPTH EXCEEDING 6" MUST HAVE A PERIMETER FENCE WITH A MINIMUM HEIGHT OF 3'.
- 25. THE WASHED GRAVEL BACKFILL ADJACENT TO THE FILTER FABRIC FENCE SHALL BE REPLACED AND THE FILTER FABRIC CLEANED IF IT IS NONFUNCTIONAL BY EXCESSIVE SILT ACCUMULATION AS DETERMINED BY THE CITY OF ISSAQUAH. ALSO, ALL INTERCEPTOR SWALES SHALL BE CLEANED IF SILT ACCUMULATION EXCEEDS ONE—QUARTER DEPTH.
- 26. PRIOR TO OCTOBER 1 OF EACH YEAR (THE BEGINNING OF THE WET SEASON), ALL DISTURBED AREAS SHALL BE REVIEWED TO IDENTIFY WHICH ONES CAN BE SEEDED IN PREPARATION FOR THE WINTER RAINS. THE IDENTIFIED DISTURBED AREA SHALL BE SEEDED WITHIN ONE WEEK AFTER OCTOBER 1. A SITE PLAN DEPICTING THE AREAS TO BE SEEDED AND THE AREAS TO REMAIN UNCOVERED SHALL BE SUBMITTED TO THE PUBLIC WORKS CONSTRUCTION INSPECTOR. THE INSPECTOR CAN REQUIRE SEEDING OF ADDITIONAL AREAS IN ORDER TO PROTECT SURFACE WATERS, ADJACENT PROPERTIES, OR DRAINAGE FACILITIES.
- 27. ANY AREA TO BE USED FOR INFILTRATION OR PERVIOUS PAVEMENT (INCLUDING A 5-FOOT BUFFER) MUST BE SURROUNDED BY SILT FENCE PRIOR TO CONSTRUCTION AND UNTIL FINAL STABILIZATION OF THE SITE TO PREVENT SOIL CIMPACTION AND SILTATION BY CONSTRUCTION ACTIVITIES.
- 28. IF THE TEMPORARY CONSTRUCTION ENTRANCE IS LOCATED IN THE SAME AREA TO BE USED FOR INFILTRATION OR PERVIOUS PAVEMENT, 6" OF SEDIMENT BELOW THE GRAVEL CONSTRUCTION ENTRANCE SHALL BE REMOVED PRIOR TO INSTALLATION OF THE INFILTRATION FACILITY OR PERVIOUS PAVEMENT (TO REMOVE FINES ACCUMULATED DURING CONSTRUCTION).
- 29. ANY CATCH BASINS COLLECTING RUNOFF FROM THE SITE, WHETHER THEY ARE ON OR OFF THE SITE, SHALL HAVE THEIR GRATES COVERED WITH FILTER FABRIC DURING CONSTRUCTION. CATCH BASINS DIRECTLY DOWNSTREAM OF THE CONSTRUCTION ENTRANCE OR ANY OTHER CATCH BASIN AS DETERMINED BY THE CITY INSPECTOR SHALL BE PROTECTED WITH A "STORM DRAIN PROTECTION INSERT" OR EQUIVALENT.
- 30. IF A SEDIMENT POND IS NOT PROPOSED, A BAKER TANK OR OTHER TEMPORARY GROUND AND/OR SURFACE WATER STORAGE TANK MAY BE REQUIRED DURING CONSTRUCTION, DEPENDING ON WEATHER CONDITIONS.
- 31. DO NOT FLUSH CONCRETE BY—PRODUCTS OR TRUCKS NEAR OR INTO THE STORM DRAINAGE SYSTEM. IF EXPOSED AGGREGATE IS FLUSHED INTO THE STORM SYSTEM, IT COULD MEAN RE—CLEANING THE ENTIRE DOWNSTREAM STORM SYSTEM, OR POSSIBLY RE—LAYING THE STORM LINE.
- 32. CONSTRUCTION DEWATERING DISCHARGES SHALL ALWAYS MEET WATER QUALITY GUIDELINES LISTED IN ISSAQUAH STANDARDS. SPECIFICALLY, DISCHARGES TO THE PUBLIC STORMWATER DRAINAGE SYSTEM MUST BE BELOW 25NTU, AND NOT CONSIDERED A PROHIBITED DISCHARGE. TEMPORARY DISCHARGES TO SANITARY SEWER REQUIRE PRIOR AUTHORIZATION AND PERMIT FROM KING COUNTY INDUSTRIAL WASTE PROGRAM (206–263–3000) AND NOTIFICATION TO THE PUBLIC WORKS CONSTRUCTION INSPECTOR.

EXISTING UTILITY NOTE

LOCATION OF EXISTING UTILITIES SHOWN, IF ANY, IS APPROXIMATE AND MAY NOT BE ACCURATE OR ALL INCLUSIVE. IT IS THE CONTRACTOR'S RESPONSIBILITY TO FIELD VERIFY LOCATION AND DEPTH OF ALL UTILITIES PRIOR TO PROCEEDING WITH CONSTRUCTION. AGENCIES INVOLVED SHALL BE NOTIFIED WITHIN A REASONABLE TIME PRIOR TO THE START OF CONSTRUCTION.

SURVEY NOTE

EXISTING SURVEY FEATURES, BOUNDARY AND TOPOGRAPHIC DATA SHOWN ON THESE DRAWINGS HAS BEEN PREPARED, BASED UPON INFORMATION FURNISHED BY TERRANE LAND SURVEYING, INC.. WHILE THIS INFORMATION IS BELIEVED TO BE RELIABLE, LITCHFIELD ENGINEERING CANNOT ENSURE THE ACCURACY AND THUS IS NOT RESPONSIBLE FOR THE ACCURACY OF DATA/INFORMATION PROVIDED BY OTHERS, OR FOR ANY ERRORS OR OMISSIONS WHICH MAY HAVE BEEN INCORPORATED INTO THESE DRAWINGS AS A RESULT.

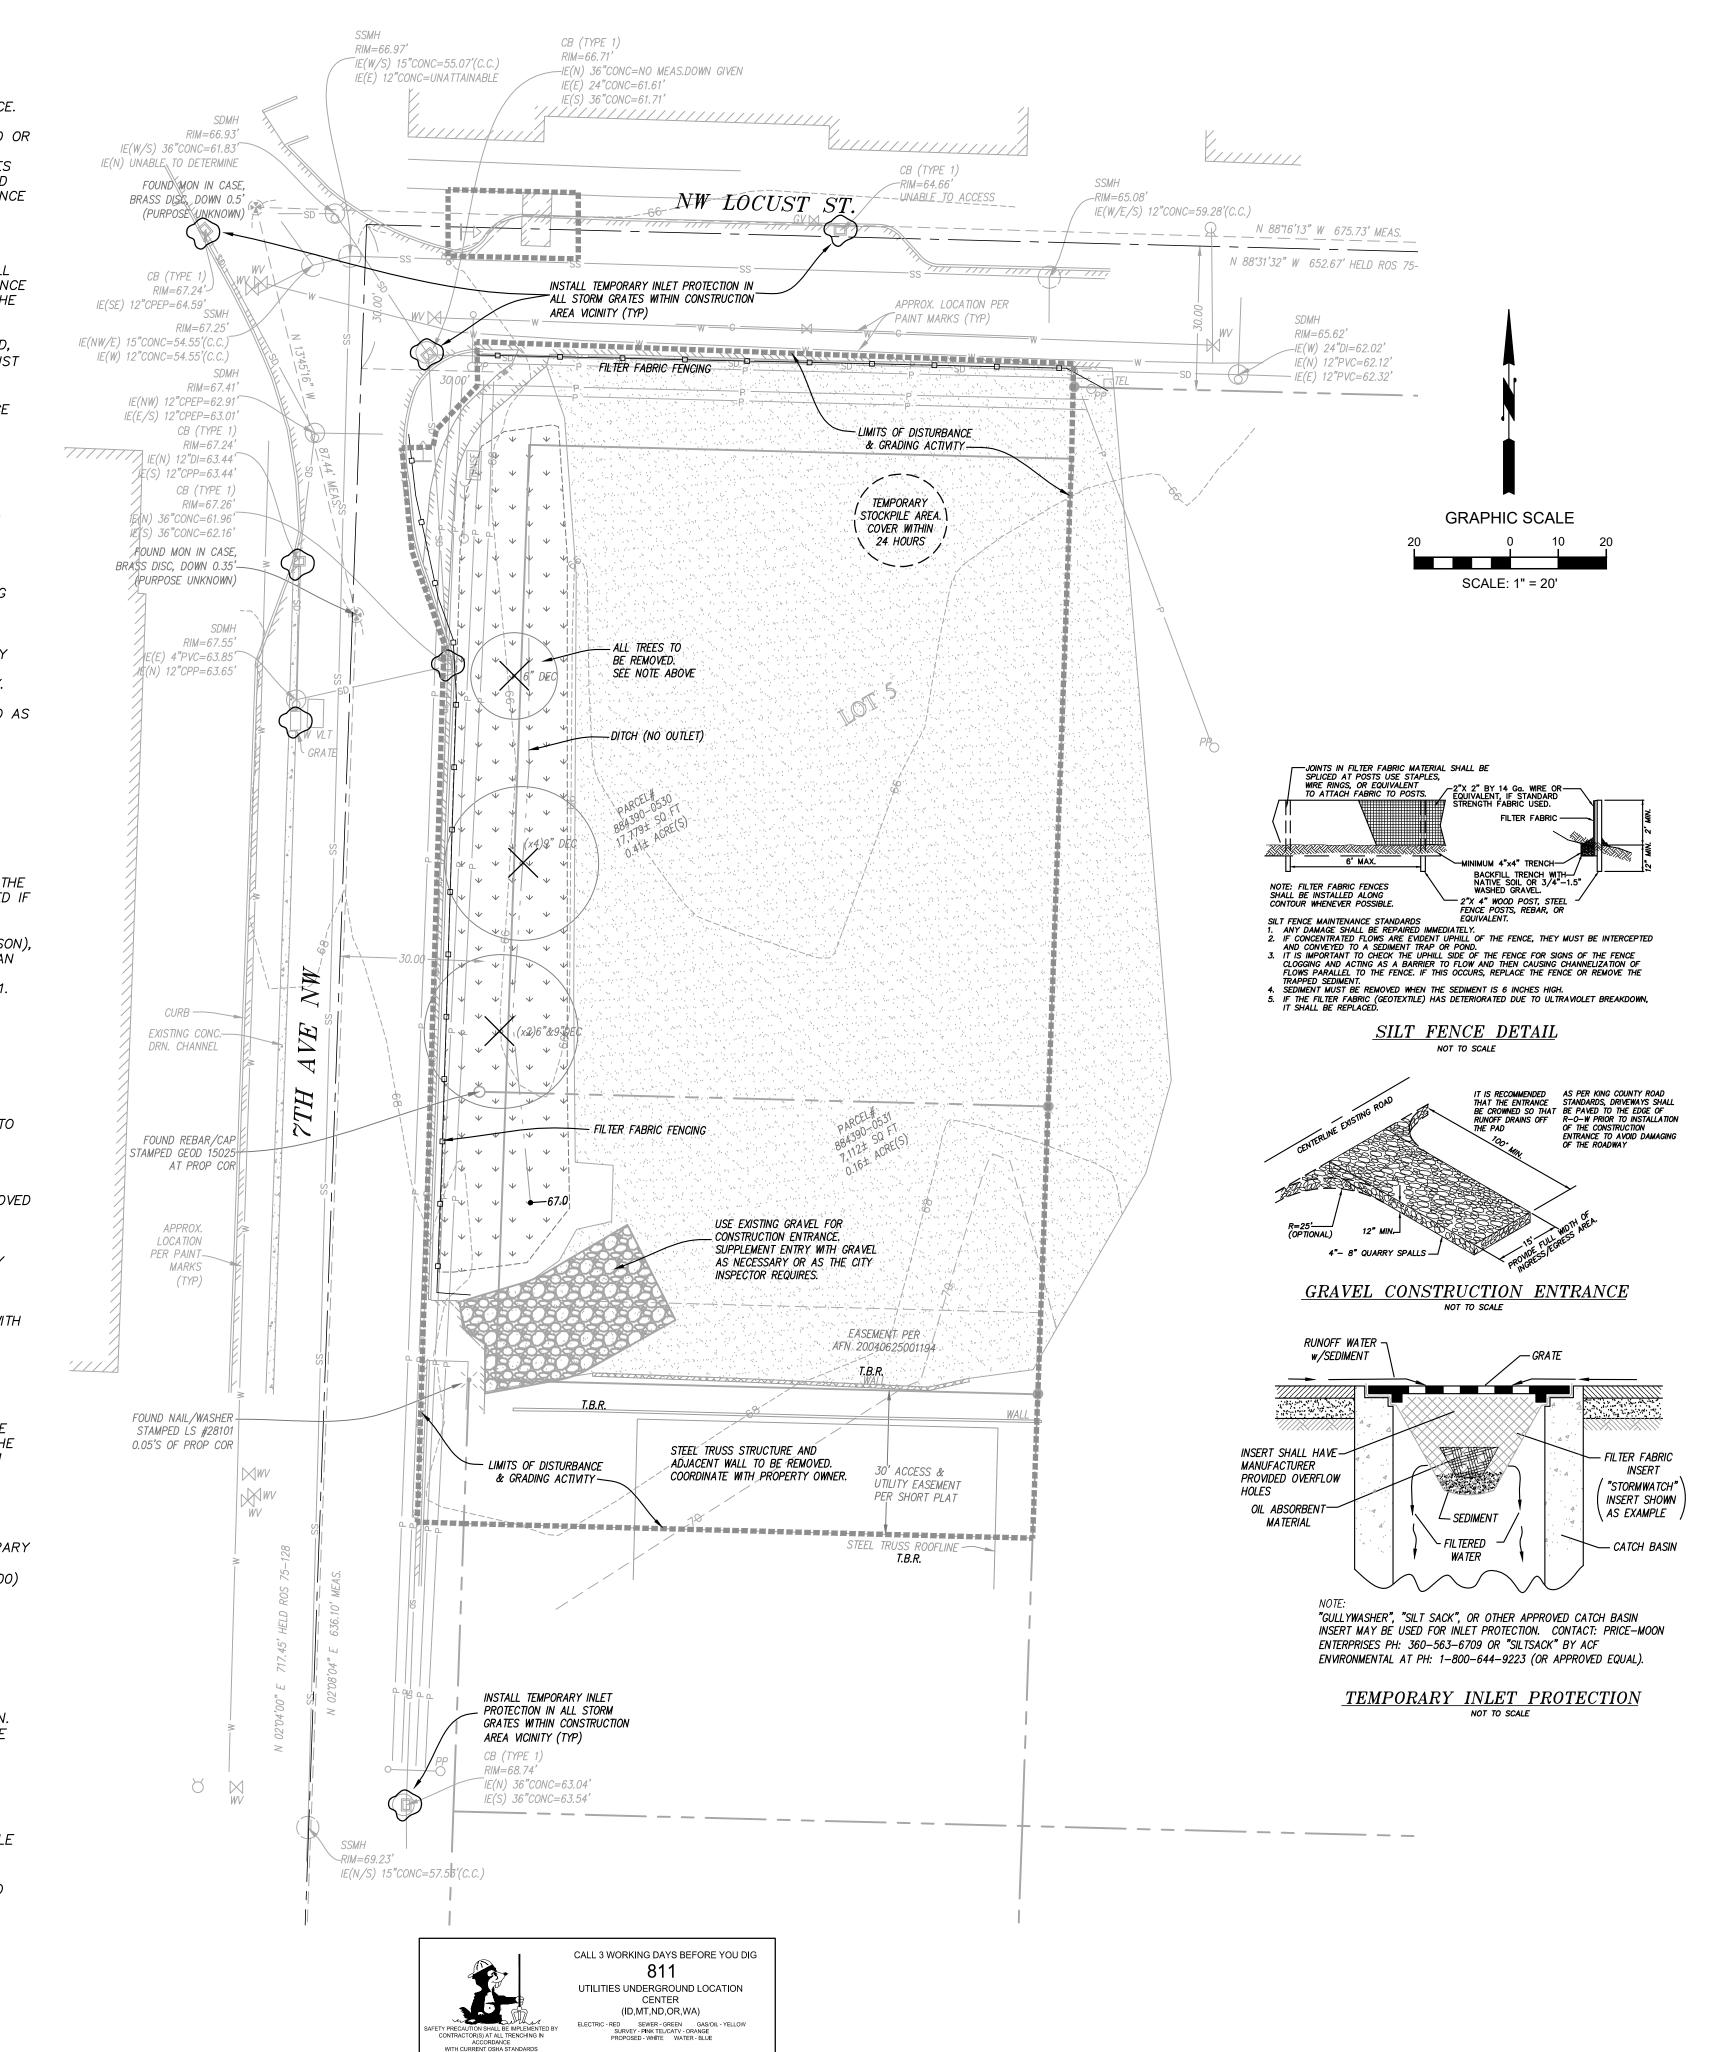

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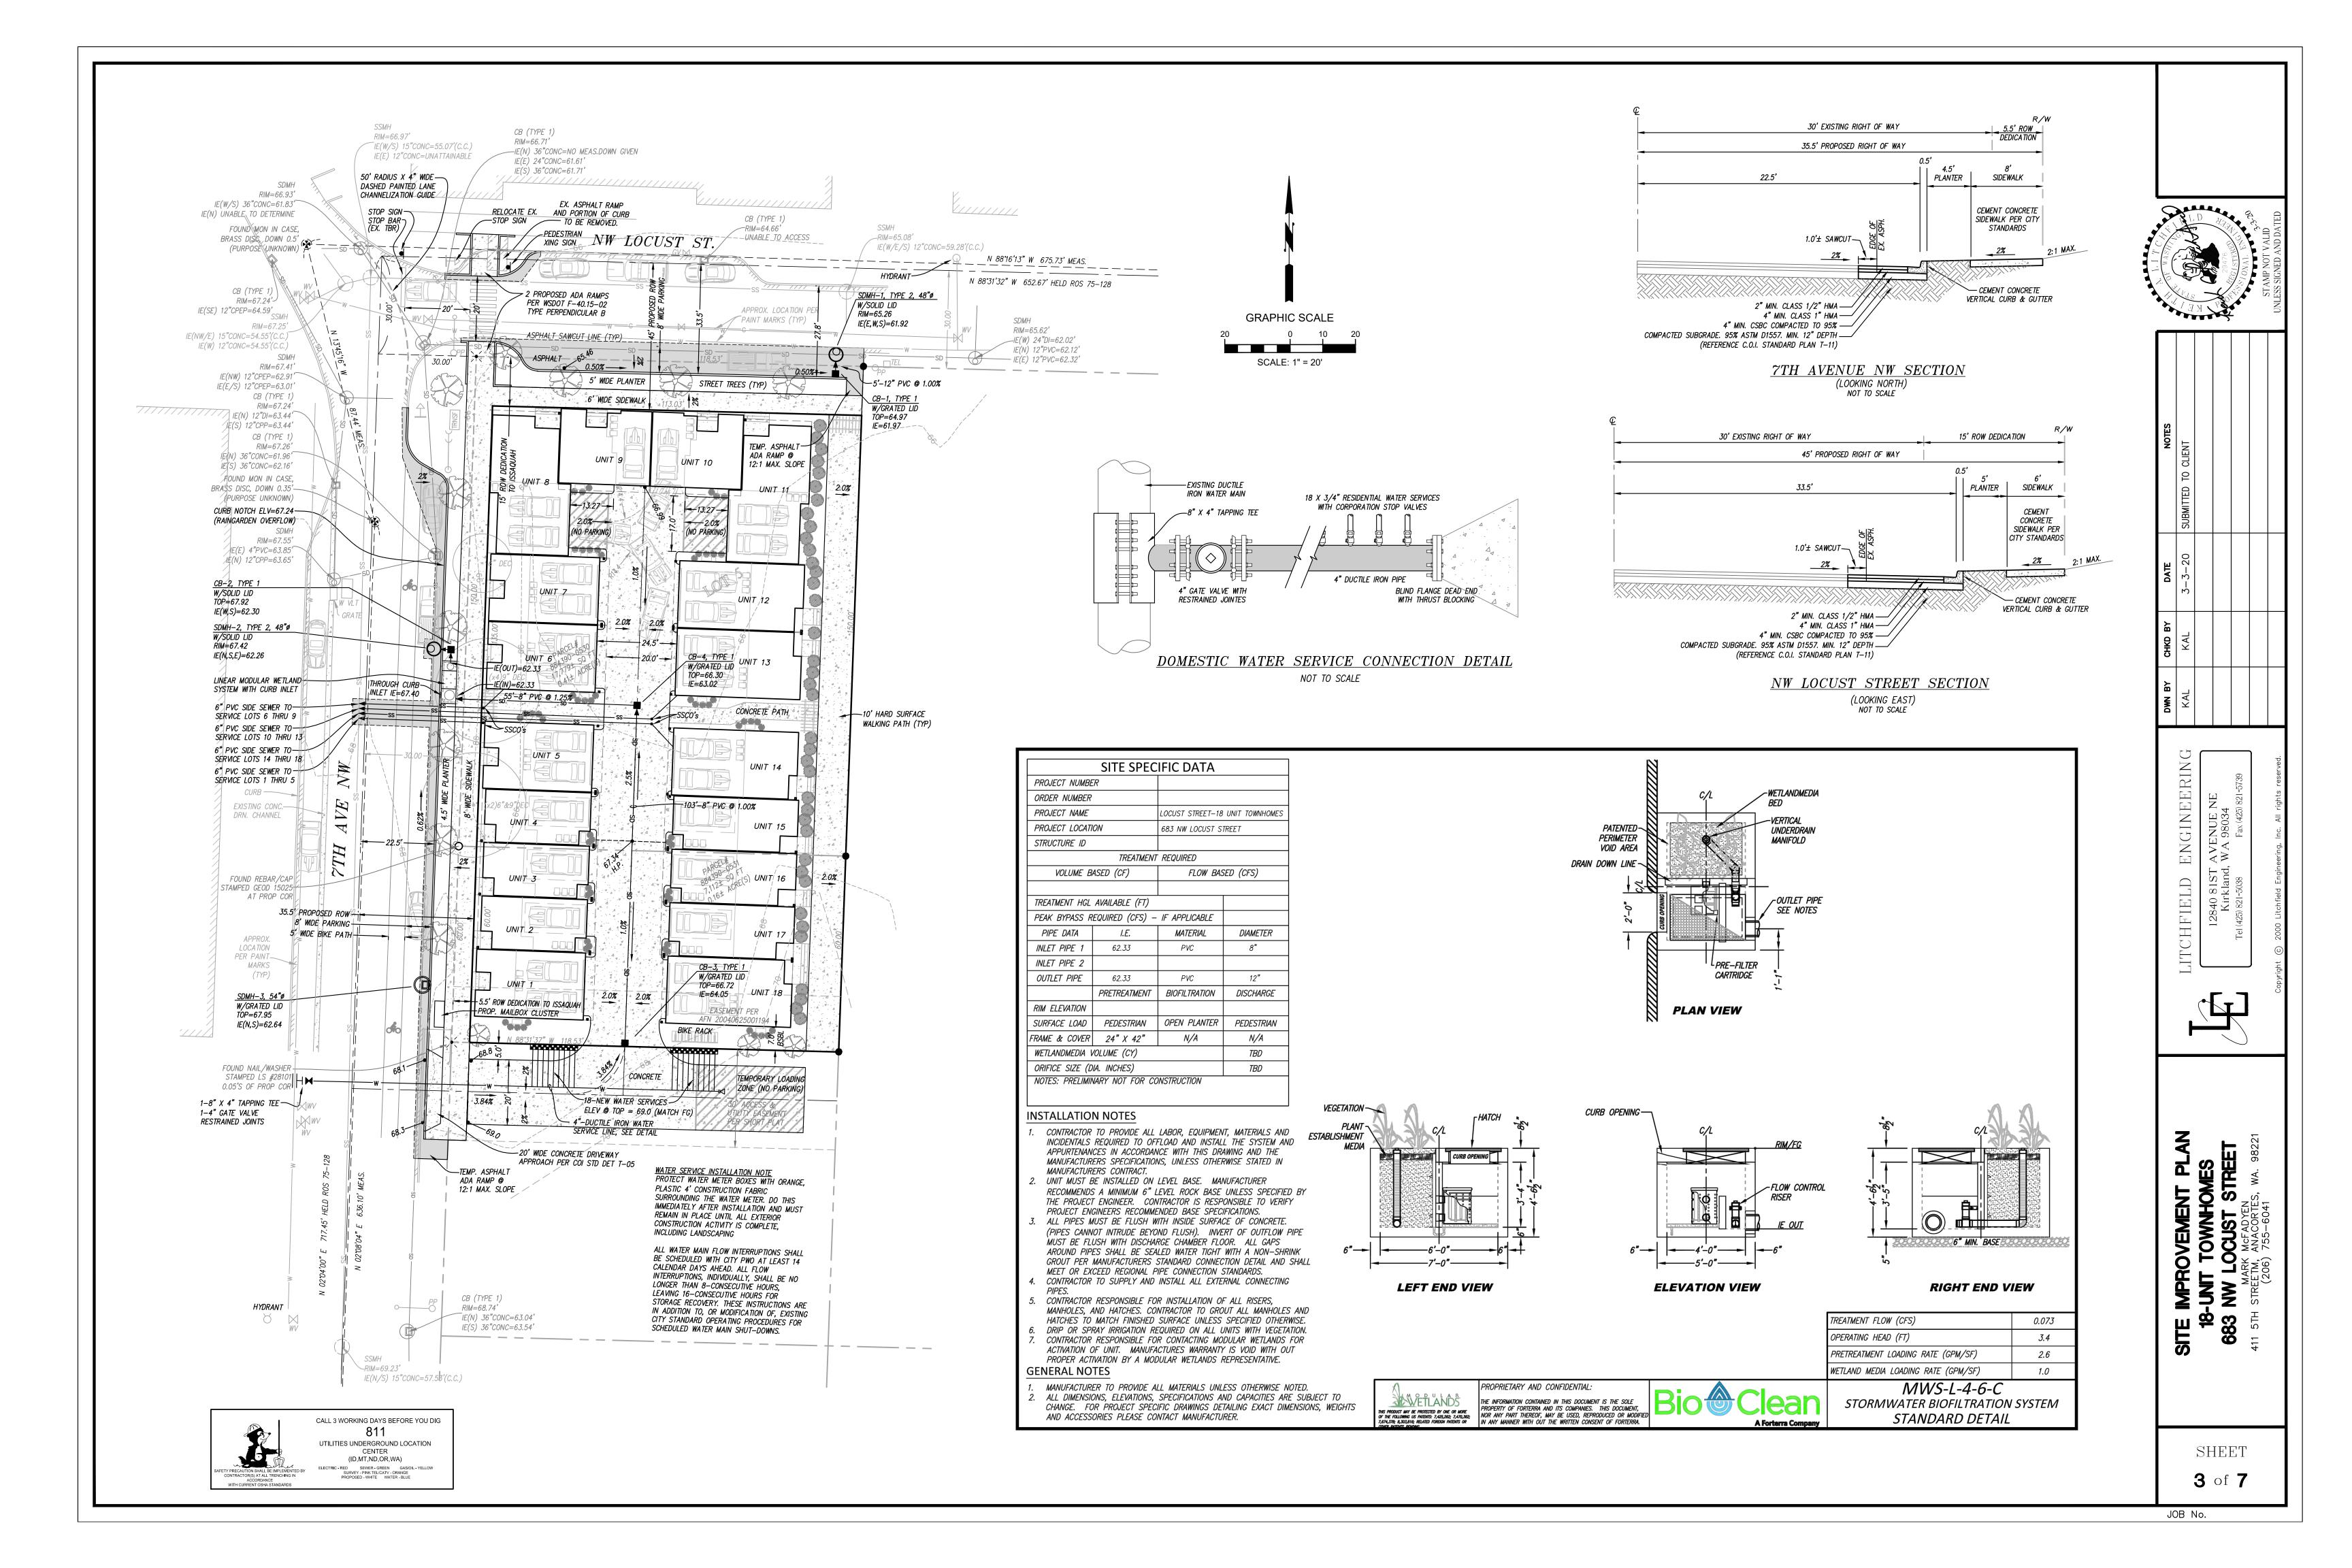
|FIELD ENGINEERIN 12840 81ST AVENUE NE Kirkland, WA 98034 (425) 821-5038 Fax (425) 821-5739

PLAN WNHOMES UST STREET

> 18-UNI 18-UNI 883 NW

SHEET

2 of **7**



GENERAL NOTES

- 1. A PRE-CONSTRUCTION CONFERENCE SHALL BE HELD PRIOR TO THE START OF CONSTRUCTION. THE CONTRACTOR SHALL BE RESPONSIBLE FOR SECURING ALL NECESSARY PERMITS PRIOR TO CONSTRUCTION.
- 2. ALL ROADWAY WORK AND MATERIAL SHALL BE IN ACCORDANCE WITH THE CURRENT APWA AND CITY OF ISSAQUAH STANDARDS AND SPECIFICATIONS.
- 3. ALL PUBLIC ROADWAYS SHALL BE CONSTRUCTED OF 2" CLASS "B" AC PAVING ON 4" ASPHALT—TREATED BASE (ATB), UNLESS OTHERWISE APPROVED BY THE PUBLIC WORKS DEPARTMENT.
- 4. A COPY OF THE APPROVED ROADWAY PLANS MUST BE ON THE JOB SITE WHENEVER CONSTRUCTION IS IN PROGRESS.
- 5. DENSITY TEST REPORTS WILL BE REQUIRED FOR ALL PUBLIC ROADWAYS AND ALL PRIVATE ROADWAYS WITHIN PLATS. ALL TRENCH BACKFILL SHALL BE COMPACTED TO 95 PERCENT DENSITY IN ROADWAYS, ROADWAY SHOULDERS, ROADWAY PRISM AND DRIVEWAYS, AND 85 PERCENT DENSITY IN UNPAVED AREAS. ALL PIPE ZONE COMPACTION SHALL BE 95
- 6. ALL COMMERCIAL AND RESIDENTIAL DRIVEWAYS MUST CONFORM TO THE CITY OF ISSAQUAH DEPARTMENT OF PUBLIC WORKS DRIVEWAY POLICY.
- 7. ALL CONCRETE FOR SIDEWALKS AND CURB AND GUTTER MUST BE 4,000 PSI MINIMUM. (5-3/4 SACK MIX.)
- 8. IN THE CASE OF NEW ROAD CONSTRUCTION OR RECONSTRUCTION REQUIRING MAILBOXES TO BE MOVED OR REARRANGED, THE DEVELOPER/CONTRACTOR SHALL COORDINATE WITH THE U.S. POSTAL SERVICE FOR THE NEW LOCATION OF THE MAILBOX STRUCTURE.
- 9. ANY ROADWAY SIGNAGE OR STRIPING REMOVED OR TEMPORARILY MOVED BY THE CONTRACTOR SHALL BE RESTORED SO AS TO MEET THE CURRENT CITY OF ISSAQUAH STANDARDS.
- 10. IT IS THE RESPONSIBILITY OF THE CONTRACTOR TO PROVIDE ADEQUATE TEMPORARY TRAFFIC CONTROL TO ENSURE TRAFFIC SAFETY DURING CONSTRUCTION ACTIVITIES. THEREFORE, THE CONTRACTOR SHALL SUBMIT A TRAFFIC CONTROL PLAN TO THE PUBLIC WORKS DEPARTMENT AT LEAST 48 HOURS PRIOR TO STARTING ANY WORK IN THE RIGHT—OF—WAY. ALL TRAFFIC CONTROL DEVICES SHALL CONFORM TO THE "MANUAL ON UNIFORM TRAFFIC CONTROL DEVICES" (MUTCD) OR AS MODIFIED BY THE TRAFFIC ENGINEER.
- 11. WHERE A SIDEWALK IS TO BE CONSTRUCTED ABOVE A SLOPE OR ADJACENT TO A ROCKERY OR RETAINING WALL WHERE THE LOWEST FINISHED ELEVATION OF THE SLOPE, ROCKERY, OR RETAINING WALL IS TO BE THIRTY INCHES (30") OR MORE BELOW THE FINISHED ELEVATION OF THE SIDEWALK, A SAFETY RAILING SHALL BE REQUIRED WHEN: (A) THE PLANE OF THE WALL FACE IS LESS THAN 4' IN HORIZONTAL DISTANCE FROM THE OUTSIDE EDGE OF THE SIDEWALK; (B) THE SLOPES ADJACENT TO THE SIDEWALK AVERAGE GREATER THAN TWO
- 12. THE MAXIMUM GRADE FOR PRIVATE ROADWAYS SHALL BE TWENTY PERCENT (20%), OR FIFTEEN PERCENT (15%) IF USED FOR FIRE ACCESS. FOR PUBLIC ROADWAYS, THE MAXIMUM GRADE SHALL BE FIFTEEN PERCENT (15%)
- 13. DEAD—END STREETS SHALL BE APPROPRIATELY SIGNED AND BARRICADED. SEE MOST CURRENT EDITION OF THE MUTCD.
- 14. SIDEWALK AND CURB AND GUTTER CANNOT BE POURED MONOLITHICALLY. THERE MUST BE A COLD JOINT OR FULL—DEPTH EXPANSION JOINT BETWEEN THEM.
- 15. MEASURES SHALL BE TAKEN BY THE DEVELOPER TO PROVIDE GROUND COVER IN AREAS WITHIN THE RIGHT—OF—WAY WHICH HAVE BEEN STRIPPED OF NATURAL VEGETATION OR HAVE A POTENTIAL FOR EROSION.
- 16. THE DEVELOPER SHALL COORDINATE WITH PUGET POWER FOR THE DESIGN AND INSTALLATION OF STREET LIGHTS ON ALL NEWLY—CREATED PUBLIC ROADWAYS AND EXISTING ROADWAYS.
- 17. WHEN AN EXISTING ROADWAY IS TO RECEIVE A HALF—STREET OVERLAY, THE EXISTING ROADWAY MUST BE COLD PLANED AT THE EDGE OF THE GUTTER AND CENTERLINE. WHEN THE EXISTING ROADWAY IS TO RECEIVE A FULL—STREET OVERLAY, IT MUST BE COLD PLANED AT THE EDGE OF BOTH GUTTERS.
- 18. ALL NEW SIGNS REQUIRED IN THE PUBLIC RIGHT-OF-WAY MUST BE PURCHASED FROM, AND INSTALLED BY, THE CITY OF ISSAQUAH PUBLIC WORKS DEPARTMENT.
- 19. WHEN INSTALLING NEW SIDEWALK, THE AREA BEHIND THE SIDEWALK MUST BE GRADED SO THAT THE YARD DRAINAGE DOES NOT DRAIN OVER THE SIDEWALK.
- 20. ANY EXISTING PUBLIC IMPROVEMENTS DAMAGED DURING CONSTRUCTION SHALL BE REPLACED PRIOR TO FINAL INSPECTION.
- 21. THE CONTRACTOR IS RESPONSIBLE FOR KEEPING ALL PUBLIC STREETS FREE FROM MUD AND DEBRIS AT ALL TIMES. THE CONTRACTOR SHALL BE PREPARED TO USE POWER SWEEPERS OR OTHER PIECES OF EQUIPMENT NECESSARY TO KEEP THE ROADWAYS CLEAN.
- 22. BACKFILL IN ALL STREET CUTS ON ARTERIALS WILL BE CONTROL DENSITY FILL (CDF).
 CONTRACTOR MUST PROVIDE STEEL PLATING NECESSARY TO ALLOW THE CDF TO CURE.
- 23. WHEN CONSTRUCTING NEW CURB AND GUTTER WHICH DOES NOT ALIGN WITH THE EXISTING EDGE OF PAVEMENT, THE ROADWAY MUST BE TAPERED FROM THE ENDS OF THE NEW CURB AND GUTTER TO MATCH THE EXISTING PAVEMENT. THE ENTRY TAPER INTO THE NEW IMPROVEMENTS SHALL BE 5:1, AND LEAVING THE NEW IMPROVEMENTS SHALL BE 10:1.
- 24. WHEN AN EXISTING ROADWAY IS TO BE WIDENED, THE EXISTING PAVEMENT MUST BE SAW CUT AT LEAST ONE FOOT FROM THE EDGE TO PROVIDE A PROPER MATCH BETWEEN NEW AND EXISTING ASPHALT. HOWEVER, WHEN THE EXISTING PAVEMENT CONTAINS ALLIGATORED AREAS, THOSE AREAS MUST BE REMOVED PRIOR TO WIDENING. ALL SAW CUTS SHALL BE PARALLEL OR PERPENDICULAR TO THE RIGHT—OF—WAY CENTERLINE.
- 25. ALL ROCKERIES MUST BE CONSTRUCTED IN ACCORDANCE WITH THE MOST CURRENT GUIDELINES OF THE ASSOCIATION.

ADDITIONAL NOTES

- 1. A 2—INCH ASPHALT STREET OVERLAY WILL BE REQUIRED WHERE MORE THAN THREE UTILITY TRENCH CROSSINGS OCCUR WITHIN 150 LINEAR FT. OF STREET LENGTH OR WHERE UTILITY TRENCHES PARALLEL THE STREET CENTERLINE. GRINDING OF THE EXISTING ASPHALT TO BLEND IN THE OVERLAY WILL BE REQUIRED ALONG ALL MATCH LINES.
- 2. UNDERGROUND ALL NEW AND EXISTING ON—SITE TRANSMISSION LINES FROM THE BUILDING TO THE POINT OF ORIGIN AT THE PRIMARY/DISTRIBUTION LINES FOR THE UTILITIES. ADJUST ANY EXISTING UTILITY WHICH MAY CONFLICT WITH STREET OR UTILITY IMPROVEMENTS.
- 3. MAILBOX LOCATION TO BE REVIEWED BY THE ISSAQUAH POSTMASTER.

WATER GENERAL NOTES

- 1. A PRE-CONSTRUCTION CONFERENCE SHALL BE HELD PRIOR TO THE START OF CONSTRUCTION.
 THE CONTRACTOR SHALL BE RESPONSIBLE FOR SECURING ALL NECESSARY PERMITS PRIOR TO
 CONSTRUCTION
- 2. ALL WATER MAIN WORK AND MATERIAL SHALL BE IN ACCORDANCE WITH CURRENT AWWA, WSDOT, AND APWA STANDARD SPECIFICATIONS, AS AMENDED BY THE CITY OF ISSAQUAH. ALL MATERIAL UTILIZED SHALL BE NEW, NO PARTS SHALL BE REUSED. ANY PART REMOVED FROM THE SYSTEM FOR ANY REASON MAY NOT BE REUSED AND SHALL BE REPLACED WITH A NEW PART. (E.G. A ROMAC WITH A BAD GASKET MUST BE REPLACED WITH AN ENTIRELY NEW ROMAC ASSEMBLY).
- 3. THE WATER MAIN SHALL BE CLASS 52 DUCTILE IRON PIPE CONFORMING TO ANSI/AWWA C151/A21.51-86 OR THE MOST RECENT REVISION. THE PIPE SHALL BE 1/16" CEMENT LINED AND SEALED IN ACCORDANCE WITH ANSI/AWWA C104/A21.4-90. THE CAST IRON OR DUCTILE IRON PIPE FITTINGS SHALL BE CLASS 250 AS PER ANSI/AWWA C110/A21.10-82. PIPE BEDDING SHALL BE COMPACTED TO 95 PERCENT OF ITS MAXIMUM DENSITY AT OPTIMUM MOISTURE CONTENT. THE MAIN SHALL BE INSTALLED WITH A MINIMUM COVER OF 36" AND A MAXIMUM COVER OF 60". ANY DEVIATIONS FROM THIS MUST BE APPROVED BY THE CITY OF ISSAQUAH PRIOR TO CONSTRUCTION.
- 4. CONCRETE BLOCKING FOR WATER MAINS SHALL BE DESIGNED AND INSTALLED IN ACCORDANCE WITH AWWA AND CITY OF ISSAQUAH SPECIFICATIONS AND SHALL BE INSTALLED AT ALL VERTICAL AND HORIZONTAL BENDS AND FITTINGS. PRIOR TO BLOCKING, THE FITTINGS SHALL BE WRAPPED WITH VISQUEEN.
- 5. ALL CONNECTIONS TO EXISTING MAINS AND ALL TESTING AND DISINFECTION SHALL BE PERFORMED UNDER THE SUPERVISION OF THE CITY OF ISSAQUAH DEPARTMENT OF PUBLIC WORKS INSPECTOR.
- APPROXIMATE LOCATIONS OF EXISTING UTILITIES HAVE BEEN OBTAINED FROM AVAILABLE RECORDS AND ARE SHOWN FOR CONVENIENCE. THE CONTRACTOR SHALL BE RESPONSIBLE FOR VERIFICATION OF THE LOCATIONS SHOWN AND FOR DISCOVERY OF POSSIBLE ADDITIONAL UTILITIES NOT SHOWN SO AS TO AVOID DAMAGE OR DISTURBANCE. THE UNDERGROUND UTILITY LOCATION SERVICE SHALL BE CONTACTED FOR FIELD LOCATION PRIOR TO ANY CONSTRUCTION. THE OWNER OR HIS REPRESENTATIVE SHALL BE CONTACTED IF A UTILITY CONFLICT EXISTS. FOR UTILITY LOCATION IN KING COUNTY, CALL 1—800—424—5555. THE CONTRACTOR IS RESPONSIBLE TO ENSURE THAT UTILITY LOCATES ARE MAINTAINED THROUGHOUT THE LIFE OF THE PROJECT.
- ALL CONTRACTORS WORKING WITH AC PIPE MUST BE STATE—CERTIFIED. THE CONTRACTOR SHALL PROVIDE PROTECTIVE CLOTHING AND EQUIPMENT (COVERALLS, GLOVES, BOOTS, HEAD COVERING, GOGGLES, RESPIRATORS, ETC.) TO CREWS WORKING WITH ASBESTOS CEMENT PIPE IN ORDER TO ASSURE THE WORKER'S EXPOSURE TO ASBESTOS MATERIAL IS AT OR BELOW THE LIMITS PRESCRIBED IN WAC 296—62—07705.
- 8. AN APPROVED COPY OF THE WATER PLAN MUST BE ON SITE WHENEVER CONSTRUCTION IS IN PROGRESS.
- 9. A 5' MINIMUM HORIZONTAL SEPARATION SHALL BE MAINTAINED BETWEEN ALL WATER FACILITIES AND UNDERGROUND POWER AND TELEPHONE FACILITIES, UNLESS OTHERWISE APPROVED BY THE CITY OF ISSAQUAH.
- O. FOR WATER MAIN AND SEWER MAIN SEPARATION REQUIREMENTS, SEE ITEM VIII.C OF THE SANITARY SEWER DESIGN CRITERIA SECTION AND DETAIL W.01.
- PRESSURE AND PURITY TESTING SHALL BE DONE IN THE PRESENCE OF, AND UNDER THE SUPERVISION OF, A CITY OF ISSAQUAH DEPARTMENT OF PUBLIC WORKS INSPECTOR. THE CONTRACTOR SHALL PROVIDE ALL PLUGS AND TEMPORARY BLOWOUT ASSEMBLIES FOR PRESSURE TESTING AND DISINFECTION PRIOR TO FINAL TIE—IN. NO CONNECTION SHALL BE MADE BETWEEN THE NEW MAIN AND THE EXISTING MAINS UNTIL THE NEW PIPING HAS BEEN DISINFECTED, FLUSHED, AND PASSED BOTH PRESSURE AND PURITY TESTING. TEMPORARY PLUGS AND BLOCKING SHALL BE INSTALLED AT THE POINTS OF CONNECTION TO THE EXISTING SYSTEM. FOR CONSTRUCTION OF NEW WATER MAIN, THE SERVICES, HYDRANTS ETC., WILL BE TESTED WITH THE MAIN. PRESSURE TESTING WILL REQUIRE A MINIMUM OF 200 PSI FOR 15 MINUTES LAST REVISED 03/2009PRE—APPROVED PLANS 4 WITH NO PRESSURE DROP. UPON SATISFACTORY COMPLETION OF THE PRESSURE TEST, THE LINE SHALL BE DISINFECTED, FLUSHED, AND THEN A SAMPLE SHALL BE TAKEN FOR PURITY TESTING BY THE PUBLIC WORKS INSPECTOR.
- 12. IT SHALL BE THE CONTRACTOR'S RESPONSIBILITY TO NOTIFY THE CITY OF ISSAQUAH INSPECTOR 24 HOURS IN ADVANCE OF BACKFILLING ALL WATER MAIN CONSTRUCTION. THE CONTRACTOR SHALL BE RESPONSIBLE FOR KEEPING AS—BUILT DRAWINGS OF ALL CONSTRUCTION NOT INSTALLED ACCORDING TO THE APPROVED PLANS. (THIS DOES NOT GIVE APPROVAL FOR AS—BUILT CONSTRUCTION.)
- 13. THE CONTRACTOR SHALL CONTACT THE CITY OF ISSAQUAH DEPARTMENT OF PUBLIC WORKS FIVE (5) DAYS PRIOR TO ANY WORK REQUIRING THE SHUTDOWN OF EXISTING WATER MAINS. THE CONTRACTOR IS REQUIRED TO GIVE TWO (2) WORKING DAYS NOTICE TO ALL CUSTOMERS AFFECTED BY A WATER MAIN SHUTDOWN (NOTICES AND MAPS FOR THE SHUTDOWN WILL BE PROVIDED BY THE WATER DIVISION). SHUTDOWNS SHALL BE SCHEDULED FOR MONDAYS, TUESDAYS, WEDNESDAYS, AND THURSDAYS BETWEEN 8 AM AND 2 PM. SHUTDOWNS AFFECTING INSTITUTIONS SHALL BE SCHEDULED AT NIGHT. ONLY WATER DIVISION PERSONNEL OR A DESIGNATE OF THE WATER DIVISION MANAGER MAY OPERATE VALVES, AND/OR HYDRANTS, BLOW—OFFS, ETC., FOR FILLS, SHUT DOWNS, FLUSHING, OR RECHARGING OF WATER LINES. TWO (2) WORKING DAYS NOTICE TO THE WATER DIVISION IS REQUIRED TO SCHEDULE FILLS.
- 4. THERE SHALL BE NO WATER MAIN CONSTRUCTION ON A SATURDAY, SUNDAY, OR HOLIDAYS OBSERVED BY THE CITY OF ISSAQUAH.
- 15. SHOULD THE WATER MAIN WORK NECESSITATE THE CLOSING OF CERTAIN GATE VALVES WITHIN THE EXISTING SYSTEM, THE CITY OF ISSAQUAH MAINTENANCE DEPARTMENT SHALL BE RESPONSIBLE FOR THE OPERATION OF SUCH VALVES.
- 6. THE FIRE FLOW SYSTEM SHALL BE INSTALLED, TESTED, AND APPROVED PRIOR TO ABOVE—GROUND COMBUSTIBLE CONSTRUCTION.
- 7. ALL TRENCH BACKFILL SHALL BE COMPACTED TO 95 PERCENT DENSITY IN ROADWAYS, ROADWAY SHOULDERS, ROADWAY PRISM AND DRIVEWAYS, AND 85 PERCENT DENSITY IN UNPAVED AREAS. ALL PIPE ZONE COMPACTION SHALL BE 95 PERCENT.
- 18. MEGA—LUGS (OR SIMILAR PRODUCT) SHALL BE REQUIRED ON ALL FITTINGS AND VALVES FOR TIE—INS, OR BUILD—OUTS FOR TIEINS PRIOR TO A FINAL CONNECTION TO THE EXISTING WATER MAIN. APPROPRIATE CONCRETE BLOCKING IS ALSO REQUIRED IN ADDITION TO MEGA—LUGS.
- 19. FOR THE DURATION OF ANY WATER MAIN INSTALLATION PROJECT, ALL EXISTING AND NEWLY INSTALLED VALVE CANS ARE TO REMAIN ACCESSIBLE TO WATER DIVISION PERSONNEL.
- WHEN IT BECOMES NECESSARY TO RE-PLUMB THE CUSTOMER'S SIDE OF AN EXISTING WATER METER AS THE RESULT OF THE RELOCATION OF THE EXISTING SERVICE OR TO COMPLY WITH OTHER CITY OF ISSAQUAH PUBLIC WORKS SPECIFICATIONS, THE CUSTOMER'S SIDE SHALL BE RECONNECTED WITH THE APPROPRIATE PLUMBING MATERIALS (AND RELATED FITTINGS) SUCH AS BRASS, COPPER, POLYETHYLENE WITH A 200 P.S.I. RATING, OR PVC.
- 21. NO TIE—IN WILL BE ALLOWED INTO THE EXISTING TAILPIECE ON THE CUSTOMER'S SIDE OF THE METER. IF THE EXISTING METER DOES NOT HAVE A CHECK VALVE INSTALLED ON THE BACK SIDE OF THE METER (CUSTOMER'S SIDE) A CHECK VALVE CANNOT BE INSTALLED WHEN DOING THE TIE—IN.
- 22. IF A FITTING, EITHER DURING INSTALLATION OR AFTER, IS FOUND TO BE DEFECTIVE IN ANY WAY AS DETERMINED BY THE CITY, THE CONTRACTOR SHALL REPLACE THE ENTIRE FITTING AND NOT JUST THE DEFECTIVE COMPONENT.
- 23. BEGINNING JANUARY 1, 2014, ALL PIPES, PIPE FITTINGS, PLUMBING FITTINGS, AND PLUMBING FIXTURES USED FOR POTABLE WATER, MUST HAVE A MAXIMUM LEAD CONTENT NOT TO EXCEED 0.25%, PER "LEAD FREE" STANDARDS AS DEFINED IN SECTION 9 OF NSF/ANSI STANDARD 61.

STORM DRAIN GENERAL NOTES

- A PRE—CONSTRUCTION CONFERENCE SHALL BE HELD PRIOR TO THE START OF CONSTRUCTION.
 THE CONTRACTOR SHALL BE RESPONSIBLE FOR SECURING ALL NECESSARY PERMITS PRIOR TO
 CONSTRUCTION.
- 2. BEFORE ANY CONSTRUCTION MAY OCCUR, THE CONTRACTOR SHALL HAVE PLANS WHICH HAVE BEEN SIGNED AND APPROVED BY THE CITY OF ISSAQUAH PUBLIC WORKS DEPARTMENT, OBTAINED ALL CITY, COUNTY, STATE, FEDERAL AND OTHER REQUIRED PERMITS, AND HAVE POSTED ALL REQUIRED BONDS.
- 3. ALL STORM DRAINAGE IMPROVEMENTS SHALL BE DESIGNED AND CONSTRUCTED IN ACCORDANCE WITH THE LATEST EDITION OF THE CITY OF ISSAQUAH PUBLIC WORKS PRE—APPROVED PLANS AND POLICIES AND THE STANDARD SPECIFICATIONS FOR ROAD, BRIDGE AND MUNICIPAL CONSTRUCTION, PREPARED BY WSDOT AND THE AMERICAN PUBLIC WORKS ASSOCIATION (APWA).
- 4. ANY DEVIATION FROM THE APPROVED PLANS WILL REQUIRE WRITTEN APPROVAL, ALL CHANGES SHALL BE SUBMITTED TO THE CITY.
- 5. A COPY OF THE APPROVED STORM WATER PLANS MUST BE ON THE JOB SITE WHENEVER CONSTRUCTION IS IN PROGRESS.
- 6. ALL DISTURBED AREAS SHALL BE SEEDED AND MULCHED OR SIMILARLY STABILIZED TO THE SATISFACTION OF THE CITY OF ISSAQUAH DEPARTMENT OF PUBLIC WORKS FOR THE PREVENTION OF ON—SITE EROSION AFTER THE COMPLETION OF CONSTRUCTION.
- 7. MINIMUM COVER OVER STORM DRAINAGE PIPES IN ROW OR VEHICULAR PATH SHALL BE 18 INCHES, UNLESS OTHER DESIGN IS APPROVED.
- 8. STEEL PIPE SHALL HAVE ASPHALT TREATMENT #1 OR BETTER INSIDE AND OUTSIDE.
- OF OVER FIVE FEET (5') TO THE PIPE INVERT SHALL BE A TYPE II CATCH BASIN. TYPE II CATCH BASINS EXCEEDING FIVE FEET (5') IN DEPTH SHALL HAVE A STANDARD LADDER INSTALLED.

9. ALL CATCH BASINS SHALL BE TYPE I UNLESS OTHERWISE NOTED. CATCH BASINS WITH A DEPTH

- 10. ALL STORM DRAINAGE MAIN EXTENSIONS WITHIN THE PUBLIC RIGHT—OF—WAY OR IN EASEMENTS MUST BE STAKED FOR LINE AND GRADE PRIOR TO STARTING CONSTRUCTION.
- 11. ROCK FOR EROSION PROTECTION OF ROADWAY DITCHES, WHERE REQUIRED, MUST BE OF SOUND QUARRY ROCK, PLACED TO A DEPTH OF ONE FOOT (1') AND MUST MEET THE FOLLOWING SPECIFICATIONS: 4"-8" ROCK/40%-70% PASSING; 2"-4" ROCK/30%-40% PASSING; 2"-MINUS ROCK/10%-20% PASSING.
- 12. ALL PIPE, MANHOLES, CATCH BASINS, AND APPURTENANCES SHALL BE LAID ON A PROPERLY PREPARED FOUNDATION IN ACCORDANCE WITH THE CURRENT STATE OF WASHINGTON STANDARD SPECIFICATIONS FOR ROAD AND BRIDGE CONSTRUCTION (WSDOT). THIS SHALL INCLUDE NECESSARY LEVELING OF THE TRENCH BOTTOM OR THE TOP OF THE FOUNDATION MATERIAL AS WELL AS PLACEMENT AND COMPACTION OF REQUIRED BEDDING MATERIAL TO UNIFORM GRADE SO THAT THE ENTIRE LENGTH OF THE PIPE WILL BE SUPPORTED ON A UNIFORMLY DENSE, UNYIELDING BASE. IF THE NATIVE MATERIAL IN THE BOTTOM OF THE TRENCH MEETS THE REQUIREMENTS FOR "GRAVEL BACKFILL FOR PIPE BEDDING," THE FIRST LIFT OF PIPE BEDDING MAY BE OMITTED PROVIDED THE MATERIAL IN THE BOTTOM OF THE TRENCH IS LOOSENED, REGRADED, AND COMPACTED TO FORM A DENSE UNYIELDING BASE. ALL PIPE BEDDING SHALL BE APWA CLASS B, TYPE I, OR BETTER. PIPE SHALL NOT BE INSTALLED ON SOD, FROZEN EARTH, LARGE BOULDERS, OR ROCK. PIPE BEDDING FOR FLEXIBLE PIPES SHALL BE PEA GRAVEL TO THE SPRINGLINE OF THE PIPE.
- 13. CONSTRUCTION OF DEWATERING (GROUNDWATER) SYSTEMS SHALL BE IN ACCORDANCE WITH THE APWA STANDARD SPECIFICATIONS.
- 14. ISSUANCE OF A BUILDING OR LAND SURFACE MODIFICATION PERMIT BY THE CITY OF ISSAQUAH DOES NOT RELIEVE THE OWNER OF THE CONTINUING LEGAL OBLIGATION AND/OR LIABILITY CONNECTED WITH STORM SURFACE WATER DISPOSITION. FURTHER, THE CITY OF ISSAQUAH DOES NOT ACCEPT ANY OBLIGATION FOR THE PROPER FUNCTIONING AND MAINTENANCE OF THE SYSTEM DURING OR FOLLOWING CONSTRUCTION EXCEPT AS OUTLINED IN THE CITY OF ISSAQUAH PUBLIC WORKS STANDARDS.
- 15. ALL TRENCH BACKFILL SHALL BE COMPACTED TO 95 PERCENT DENSITY IN ROADWAYS, ROADWAY SHOULDERS, ROADWAY PRISM AND DRIVEWAYS, AND 85 PERCENT DENSITY IN UNPAVED AREAS.
 ALL PIPE ZONE COMPACTION SHALL BE 95 PERCENT.
- 16. THE CONTRACTOR SHALL BE RESPONSIBLE FOR PROVIDING ADEQUATE SAFEGUARDS, SAFETY DEVICES, PROTECTIVE EQUIPMENT, CONFINED SPACE PROTECTION, FLAGGERS, AND ANY OTHER NEEDED ACTIONS TO PROTECT THE LIFE, HEALTH, AND SAFETY OF THE PUBLIC, AND TO PROTECT PROPERTY IN CONNECTION WITH THE PERFORMANCE OF WORK COVERED BY THE CONTRACT. ANY WORK WITHIN THE TRAVELED RIGHT—OF—WAY THAT MAY INTERRUPT NORMAL TRAFFIC FLOW SHALL REQUIRE A TRAFFIC CONTROL PLAN APPROVED BY THE CITY OF ISSAQUAH. ALL SECTIONS OF THE WSDOT STANDARD SPECIFICATIONS, TRAFFIC CONTROL, AND THE MANUAL OF UNIFORM TRAFFIC CONTROL DEVICES (MUTCD) SHALL APPLY.
- 17. NO FINAL CUT OR FILL SLOPE SHALL EXCEED SLOPES OF TWO (2) HORIZONTAL TO ONE (1) VERTICAL WITHOUT STABILIZATION BY ROCKERY OR BY A STRUCTURAL RETAINING WALL.
- 18. ALL MANHOLE LADDERS SHALL BE FIRMLY ATTACHED AND EXTEND TO WITHIN 1' OF THE BOTTOM OF THE STRUCTURE.
- 19. APPROXIMATE LOCATIONS OF EXISTING UTILITIES HAVE BEEN OBTAINED FROM AVAILABLE RECORDS AND ARE SHOWN FOR CONVENIENCE. THE CONTRACTOR SHALL BE RESPONSIBLE FOR VERIFICATION OF EXISTING UTILITY LOCATIONS WHETHER OR NOT THESE UTILITIES ARE SHOWN ON THE PLANS. THE CONTRACTOR SHALL EXERCISE ALL CARE TO AVOID DAMAGE TO ANY UTILITY. IF CONFLICTS WITH EXISTING UTILITIES ARISE DURING CONSTRUCTION, THE CONTRACTOR SHALL NOTIFY THE CITY CONSTRUCTION INSPECTOR AND ANY CHANGES REQUIRED SHALL BE APPROVED BY THE DEVELOPMENT ENGINEER PRIOR TO COMMENCEMENT OF RELATED CONSTRUCTION ON THE PROJECT.
- 20. THE UNDERGROUND UTILITY LOCATION SERVICE SHALL BE CONTACTED FOR FIELD LOCATION OF EXISTING UTILITIES PRIOR TO ANY CONSTRUCTION. THE OWNER OR HIS REPRESENTATIVE SHALL BE CONTACTED IF A UTILITY CONFLICT EXISTS. FOR UTILITY LOCATION IN KING COUNTY, CALL 1-800-424-5555. THE CONTRACTOR IS RESPONSIBLE TO ENSURE THAT UTILITY LOCATES ARE MAINTAINED THROUGHOUT THE LIFE OF THE PROJECT.
- 21. THE CONTRACTOR SHALL VERIFY THE LOCATIONS, WIDTHS, THICKNESSES, AND ELEVATIONS OF ALL EXISTING PAVEMENTS AND STRUCTURES THAT ARE TO INTERFACE WITH NEW WORK. PROVIDE ALL TRIMMING, CUTTING, SAW CUTTING, GRADING, LEVELING, SLOPING, COATING, AND OTHER WORK, INCLUDING MATERIALS AS NECESSARY, TO CAUSE THE INTERFACE WITH EXISTING WORKS TO BE PROPER, ACCEPTABLE TO THE ENGINEER AND THE CITY OF ISSAQUAH, COMPLETE IN PLACE AND READY TO USE
- 22. ALL INLET, MANHOLE, AND CATCH BASIN FRAMES AND GRATES SHALL NOT BE ADJUSTED TO GRADE UNTIL IMMEDIATELY PRIOR TO FINAL PAVING. ALL CATCH BASIN GRATES SHALL BE SET 0.10' BELOW PAVEMENT LEVEL.
- 23. OPEN CUT ROAD CROSSINGS FOR UTILITY TRENCHES ON EXISTING TRAVELED ROADWAY SHALL BE BACKFILLED ONLY WITH 5/8" MINUS CRUSHED ROCK AND MECHANICALLY COMPACTED (UNLESS OTHERWISE APPROVED BY THE CITY). FOR STREETS CLASSIFIED AS ARTERIALS OR COLLECTORS, BACKFILL FOR CROSSINGS SHALL BE CDF. CUTS INTO THE EXISTING ASPHALT SHALL BE NEAT LINE CUT WITH SAW OR JACKHAMMER IN A CONTINUOUS LINE. A TEMPORARY COLD MIX PATCH MUST BE PLACED IMMEDIATELY AFTER BACKFILL AND COMPACTION. A PERMANENT HOT MIX PATCH SHALL BE PLACED WITHIN 30 DAYS AND SHALL BE A MINIMUM OF 1" THICKER THAN THE ORIGINAL ASPHALT WITH A MINIMUM THICKNESS OF 2". SEE STANDARD D.02.
- 24. ALL DAMAGES INCURRED TO PUBLIC AND/OR PRIVATE PROPERTY BY THE CONTRACTOR DURING THE COURSE OF CONSTRUCTION SHALL BE PROMPTLY REPAIRED TO THE SATISFACTION OF THE CITY CONSTRUCTION INSPECTOR BEFORE PROJECT APPROVAL AND/OR THE RELEASE OF THE PROJECT'S PERFORMANCE BOND.
- 25. GROUT ALL SEAMS AND OPENINGS IN ALL INLETS, CATCH BASINS, AND MANHOLES.
- 26. WHEN WIDENING AN EXISTING ROADWAY WHERE AN EXISTING TYPE I CATCH BASIN WILL REMAIN IN THE TRAVEL LANE, THE EXISTING FRAME AND COVER SHALL BE REPLACED WITH A ROUND, LOCKING FRAME AND COVER.
- 27. FOR OTHER THAN SINGLE—FAMILY DWELLINGS, ALL EXPOSED OR READILY EXPOSED INDOOR STORM DRAINAGE PIPING/PLUMBING SHALL BE LABELED WITH THE WORDS "STORM DRAIN" WITH MINIMUM 2 INCH HIGH LETTERS.

SANITARY SEWER GENERAL NOTES

- A PRE-CONSTRUCTION CONFERENCE SHALL BE HELD PRIOR TO THE START OF CONSTRUCTION. THE CONTRACTOR SHALL BE RESPONSIBLE FOR SECURING ALL NECESSARY PERMITS PRIOR TO CONSTRUCTION.
- 2. ALL CONSTRUCTION AND MATERIALS SHALL CONFORM TO CITY OF ISSAQUAH DEPARTMENT OF PUBLIC WORKS AND CURRENT WSDOT/APWA STANDARDS AND SPECIFICATIONS FOR ROAD, BRIDGE, AND MUNICIPAL CONSTRUCTION.
- 3. APPROXIMATE LOCATIONS OF EXISTING UTILITIES HAVE BEEN OBTAINED FROM AVAILABLE RECORDS AND ARE SHOWN FOR CONVENIENCE. THE CONTRACTOR SHALL BE RESPONSIBLE FOR VERIFICATION OF THE LOCATIONS SHOWN AND FOR DISCOVERY OF POSSIBLE ADDITIONAL UTILITIES NOT SHOWN SO AS TO AVOID DAMAGE OR DISTURBANCE. THE UNDERGROUND UTILITY LOCATION SERVICE SHALL BE CONTACTED FOR FIELD LOCATION PRIOR TO ANY CONSTRUCTION. THE OWNER OR HIS REPRESENTATIVE SHALL BE CONTACTED IF A UTILITY CONFLICT EXISTS. FOR UTILITY LOCATION IN KING COUNTY, CALL 1-800-424-5555. THE CONTRACTOR IS RESPONSIBLE TO ENSURE THAT UTILITY LOCATES ARE MAINTAINED THROUGHOUT THE LIFE OF THE PROJECT.
- 4. IT SHALL BE THE CONTRACTOR'S RESPONSIBILITY TO COORDINATE HIS ACTIVITIES WITH LOCAL UTILITY COMPANIES TO ENSURE THAT ALL UTILITIES ARE INSTALLED ACCORDING TO THESE PLANS AND THE REQUIREMENTS OF THE INDIVIDUAL UTILITY COMPANIES.
- 5. ALL MANHOLES SHALL CONFORM TO WSDOT/APWA STANDARDS, ECCENTRIC CONES WITH MANUFACTURERAPPROVED GASKETS AND 1/2" POLYPROPYLENE—ENCAPSULATED SAFETY STEPS AND LADDERS. ALL MANHOLES SHALL HAVE CAST IRON RINGS AND DUCTILE IRON COVERS. LIDS SHALL HAVE 2" RAISED LETTERS MARKED "SEWER." ALL CLEANOUTS SHALL HAVE CAST IRON RINGS AND COVERS MARKED "CO" THAT ARE IN PAVED AREAS.
- 6. ALL SIDE SEWERS SHALL BE TESTED FOR ACCEPTANCE AT THE SAME TIME THE MAIN SEWER IS TESTED. SIDE SEWER LOCATIONS SHALL BE VERIFIED IN THE FIELD PRIOR TO CONSTRUCTION AND BACKFILLING. ALL SIDE SEWERS SHALL BE CAPPED WITH A WATERTIGHT PLUG, HAVE A CLEANOUT AND TEST TEE INSTALLED, AND SHALL BE MARKED FOR LOCATION WITH A 2" X 4" STAKE PAINTED WHITE. MARKED SEWER. WITH 3" EXPOSED, AND THE DEPTH OF THE CAP WRITTEN ON THE STAKE. SEE STANDARD DETAIL S.18. THE STAKE SHALL BE SECURED TO THE END OF THE PLUG WITH WIRE A MINIMUM OF 16 GAUGE. INITIAL SIDE SEWER INSTALLATION SHALL RUN TO THE PROPERTY LINE. THE REMAINING SIDE SEWER SHALL NOT BE INSTALLED UNTIL TESTING AND ACCEPTANCE OF THE SEWER TRUNK LINE BY THE CITY OF ISSAQUAH IS COMPLETED. NUMBER AND LOCATION OF SIDE SEWERS SHOWN ARE APPROXIMATE ONLY AND MAY BE CHANGED AS REQUIRED DURING CONSTRUCTION. CONTRACTOR SHALL NOTIFY ENGINEER WHEN EXACT LOCATIONS ARE DETERMINED AND PROVIDE THE ENGINEER AND THE CITY OF ISSAQUAH DEPARTMENT OF PUBLIC WORKS WITH AN AS-BUILT. IF APPROVED BY THE PUBLIC WORKS DEPARTMENT, ALL DOUBLE-SIDED SEWER WYES MUST BE AT THE PROPERTY LINE.
- 7. ALL MAIN—LINE TRENCHES SHALL BE COMPACTED PRIOR TO TESTING SEWER LINES FOR ACCEPTANCE.
- 8. PRESSURE TESTING OF GRAVITY SEWER MAINS SHALL CONFORM TO THE FOLLOWING STANDARDS: (1) AIR TESTING WILL REQUIRE A MINIMUM OF 4 PSI FOR 15 MINUTES WITH NO PRESSURE DROP; (2) WATER TESTING WILL REQUIRE A MINIMUM OF 10' OF HEAD IN A STANDPIPE AT THE TEST LOCATION FOR 15 MINUTES WITH NO DROP IN THE WATER LEVEL IN THE STANDPIPE. EITHER TEST IS ACCEPTABLE.
- 9. PRESSURE TESTING OF FORCE MAINS AND LATERALS WILL REQUIRE AN AIR TEST OF 25 PSI MINIMUM FOR 15 MINUTES WITH NO PRESSURE DROP.
- 10. NEW CONNECTIONS TO EXISTING MANHOLES OR SEWER LINES SHALL BE SEALED OFF UNTIL UPSTREAM CONSTRUCTION IS FINISHED, TESTED, CLEANED, AND ACCEPTED. ALL CONSTRUCTION DEBRIS AND WATER SHALL BE REMOVED PRIOR TO OPENING THE SEAL.
- 11. ALL PVC SEWER PIPE AND FITTINGS SHALL MEET THE REQUIREMENTS OF ASTM SPECIFICATIONS D-3034 FOR 4" TO 15" DIAMETER AND ASTM F679 FOR 18" TO 27" DIAMETER. PIPE SHALL BE SDR-35 AND SHALL CONFORM TO STANDARD SPECIFICATIONS. BEDDING AND BACKFILL SHALL MEET WSDOT AND APWA SPECIFICATIONS.
- 12. MINIMUM SLOPE FOR SIDE SEWERS SHALL BE TWO PERCENT (2%).
- 13. AN APPROVED COPY OF THE SEWER PLAN MUST BE ON SITE WHENEVER CONSTRUCTION IS IN PROGRESS.
- 14. PRIOR TO CONSTRUCTION OF SEWER LINES, THE NECESSARY LOT CORNERS MUST BE SET, AND THE CONTRACTOR SHALL BE RESPONSIBLE FOR THE VERIFICATION OF THE LOCATION OF PIPES, MANHOLES, AND INVERT ELEVATIONS.
- 15. PIPE ANCHORS, IF USED, SHALL BE INSTALLED: NOT OVER 36' CENTER TO CENTER ON GRADES FROM 20 PERCENT TO 35 PERCENT; NOT OVER 24' CENTER TO CENTER ON GRADES FROM 35 PERCENT TO 50 PERCENT; AND NOT OVER 16' CENTER TO CENTER ON GRADES 50 PERCENT AND GREATER.
- 16. ALL MANHOLES SHALL HAVE A MINIMUM OF 0.10' TO A MAXIMUM OF 1.00' DROP BETWEEN INVERT IN AND INVERT OUT.
- 17. PVC SEWER PIPE SHALL BE TESTED FOR DEFLECTION ACCORDING TO WSDOT/APWA SPECIFICATIONS.
- 18. ALL TRENCH BACKFILL SHALL BE COMPACTED TO 95 PERCENT DENSITY IN ROADWAYS, ROADWAY SHOULDERS, ROADWAY PRISM AND DRIVEWAYS, AND 85 PERCENT DENSITY IN UNPAVED AREAS. ALL PIPE ZONE COMPACTION SHALL BE 95 PERCENT.
- 19. IT SHALL BE THE RESPONSIBILITY OF THE CONTRACTOR TO ADJUST ALL MANHOLE LIDS AND CLEANOUT LIDS TO MATCH FINAL ASPHALT ELEVATIONS IN ROADWAYS OR GROUND ELEVATIONS IN LANDSCAPED AREAS.
- 20. WHEN TYING INTO EXISTING MANHOLES THAT ARE BELOW MINIMUM STANDARDS, THE EXISTING MANHOLE MUST BE UPGRADED TO MEET CURRENT STANDARDS.
- 21. ALL NEW SEWER MAIN EXTENSIONS SHALL BE VIDEOED PRIOR TO FINAL ACCEPTANCE.



DWN BY CHKD BY DATE NOTES

KAL KAL 3-3-20 SUBMITTED TO CLIENT

ELD ENGINEERIN(
40 81ST AVENUE NE
Kirkland, WA 98034
821-5038 Fax (425) 821-5739

128 Tel (425

NOTES .

SAQUAH STANDARD

-UNIT TOWNHOMES

NW LOCUST STREET


MARK McFADYEN

STREETM, ANACORTES, WA. 98221

SHEET

4 of **7**

83 & 88

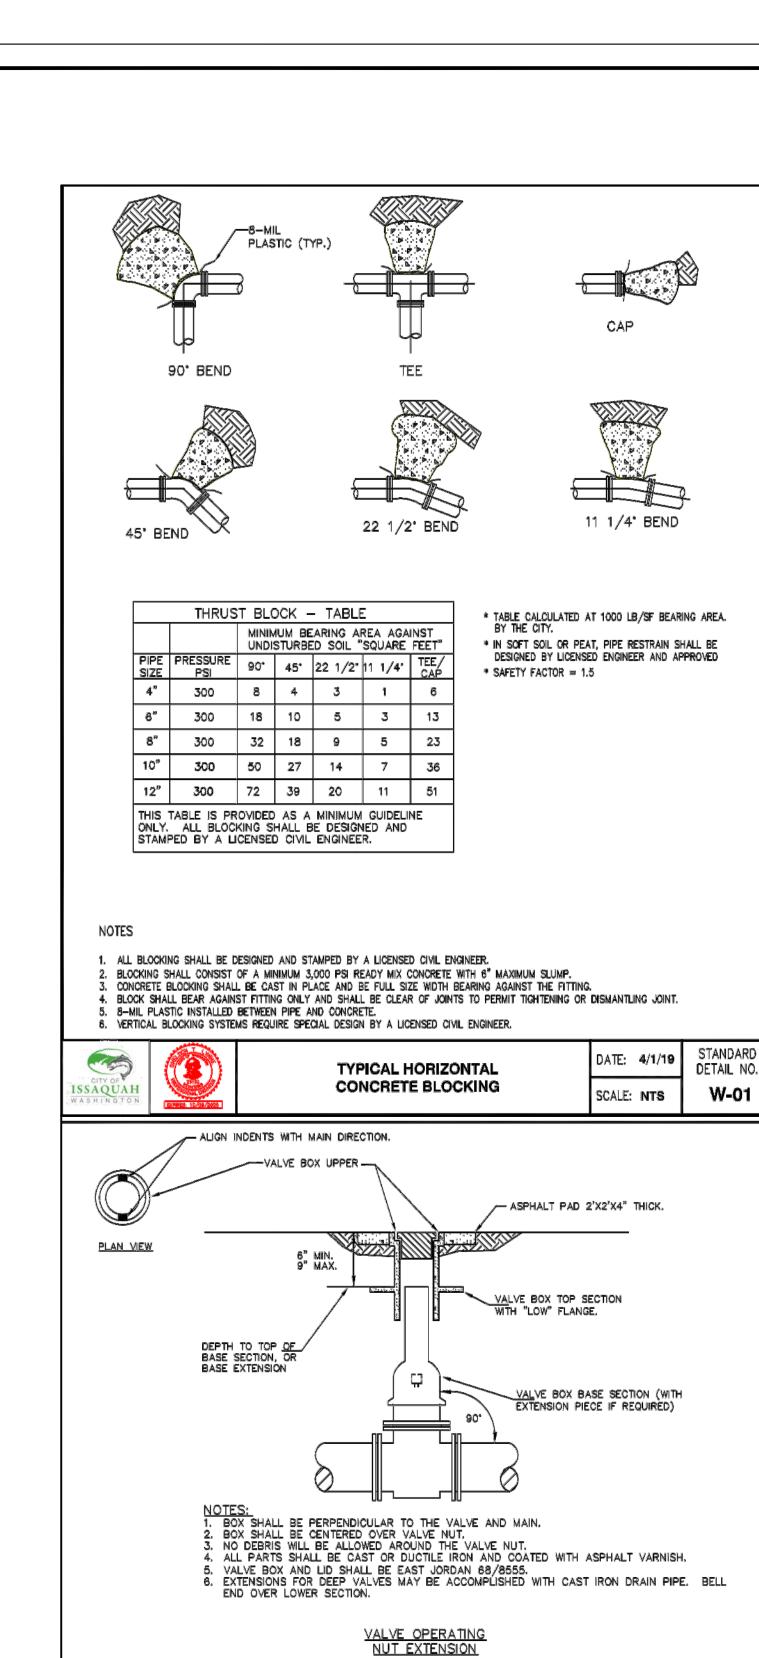

1/4" MIN. THICKNESS

2 1/4" DEPTH

WATER VALVE BOX AND

WATER VALVE EXTENSION

INSTALLATION


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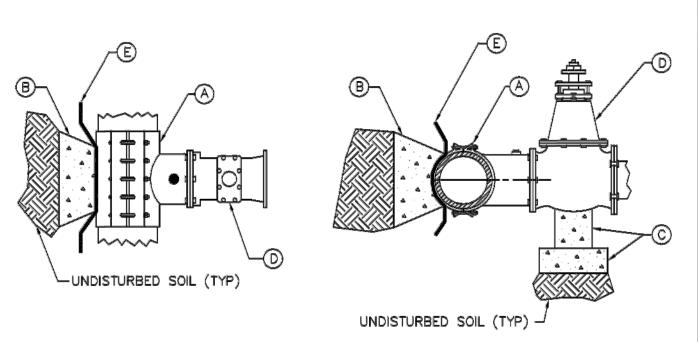
DETAIL NO.

W-21

DATE: 4/1/19

SCALE: NTS



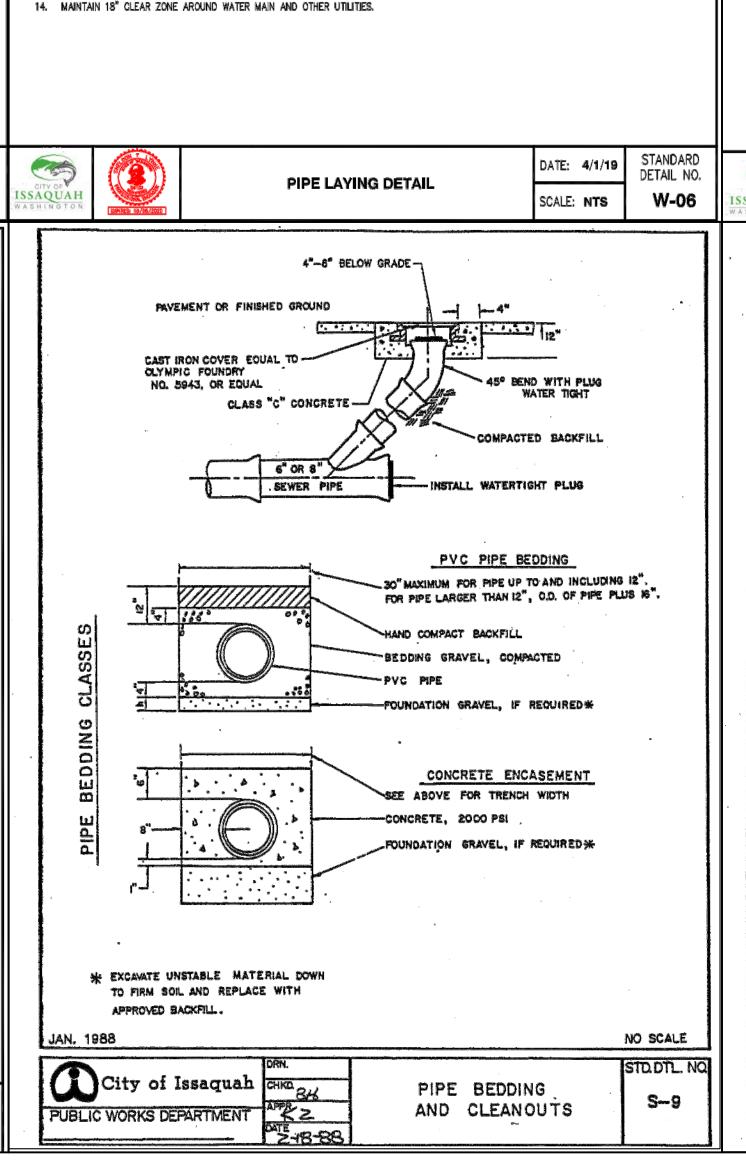

LEGEND

LOCATE WIRE WITH 6" WIDE WARNING - TAPE - REQUIRED IF DEPTH OF BURY

EXCEEDS 4'.

- DO NOT LET PIPE REST ON BELLS.

PREPARE TRENCH SO PIPE IS SUPPORTED FULL-LENGTH.
PLUG OR CAP PIPE WHENEVER NOT ACTIVELY WORKING ON PIPE SECTION. USE MJ OR TYTON JOINT PLUG OR CAP. BOARDS, BUCKETS, ETC.

THE NEW WATER MAIN SHALL BE CONNECTED TO THE EXISTING SYSTEM ONLY AFTER NEW MAIN IS FLUSHED. DISINFECTED AND SATISFACTORY

PIPES LESS THEN 20' OR LENGTHS APPROVED BY CITY ENGINEER MAY BE SWABBED WITH 500 PPM CHLORINE SCLUTION. CARE SHALL BE

PIPE LAYING OPERATIONS VIOLATING ANY SECTION OF THIS DETAIL SHALL BE IMMEDIATELY SUSPENDED UNTIL THE CITY HAS BEEN SATISFIED

ALL JOINTS & CONNECTIONS SHALL BE RESTRAINED.

PIPE THAT IS ROLLED OFF A TRUCK OR TRAILER, OR IS DROPPED OR OTHERWISE MISHANDLED WILL BE REJECTED.

11. A TORQUE WRENCH SHALL BE USED TO PROPERLY TIGHTEN BOLTS AND NUTS TO MANUFACTURER SPECIFICATIONS.

SEE APPROVED MATERIAL LIST.

CUT ENDS SHALL BE BEVELED PER MANUFACTURER SPECIFICATIONS PRIOR TO ASSEMBLY.

10. EXTREME CARE SHALL BE TAKEN TO PREVENT WATER AND/OR DEBRIS FROM ENTERING PIPE.

GASKETS SHALL BE LUBRICATED WITH APPROVED AWWA C11/A21.11-07 SEC. 4.5.4 LUBRICANT.

NOTES

LAY PIPE WITH BELLS UPGRADE.

BACTERIOLOGICAL SAMPLE RESULTS ARE OBTAINED.

NEW MAINS SHALL BE FLUSHED AT A MINIMUM VELOCITY OF 5 FPS.

TAKEN NOT TO GET CHLORINE ON THE OUTSIDE OF THE PIPE OR FITTINGS.

JOINT ASSEMBLY SHALL BE INSTALLED PER MANUFACTURER SPECIFICATIONS.

OF THE CONTRACTORS ABILITY TO MEET THESE REQUIREMENTS.

A. TAPPING TEES B. THRUST BLOCKING. SEE STANDARD DETAIL W-01 (TYPICAL HORIZONTAL CONCRETE BLOCKING).

JAN. 1988

City of Issaquah CHKD BH

PUBLIC WORKS DEPARTMENT

---5" SEWER PIPE

GENERAL MOTES:

1. WHERE SIDE SEWER CONNECTS TO MANHOLE: INVERT OF SIDE SEWER SHALL BE EQUAL TO OR ABOVE MAIN SEWER CROWN, BUT NOT TO EXCEED 18" ABOVE INVERT OF MAIN SEWER.

2. UNLESS OTHERWISE INDICATED ON

PLAN, SIDE SEWER SHALL BE MIN. OF 6' DEEP AT PROPERTY LINE, OR 5' LOWER THAN THE LOWEST ELEVATION, WHICH EVER IS LOWER.

3. TAPS ON EXISTING LINES WILL BE CORE BORED AND ROMAC STYLE "CB" SEWER SADDLE USED.

SIDE SEWER STUBS

NO SCALE

S-10

AVE WA

DET. TOWNHOMES OCUST STRE -18 683

SHEET

5 of **7**

JOB No.

STANDARD

DETAIL NO.

G-01

SCALE: NTS

BOX #1 MXU • METER FIÑGER HOLE 50% OFFSET (EITHER DIRECTION) TYPICAL ALL BOXES NO HOLES IN BRICKS -HAND COMPACTED ARÇ LENGTH TABLE BEDDING UNDER CORP. MEASURED DISTANCE PIPE SIZE 8" 12" 16" 24" ARC LENGTH 2" 3" 4" 6" A. ROMAC SADDLE 1. SERVICE LINE MUST BE INSTALLED PERPENDICULAR TO THE STAINLESS STEEL (SINGLE STRAP) SERVICE SADDLE WITH TAPER (CC) WATER MAIN. BACKFILL WITH 5%" MINUS TO 1' OVER PIPE. COMPACT TO 95% MAX. DRY DENSITY PER ASTM D-1557. TAP. DOUBLE STRAP FOR 12" AND LARGER PIPES. SERWICE SADDLES ARE REQUIRED ON ALL PIPE EXCEPT CLASS 52 OR THICKER DUCTILE IRON. THE CORP. STOP MAY BE TAPPED DIRECTLY INTO CLASS 52 OR THICKER DUCTILE IRON ROMAC 101NS FOR UP TO 12" DUCTILE & CAST IRON. ROMAC 202NS FOR 12" OR LARGER DUCTILE & CAST IRON. ROMAC SSI FOR AC. B. CORPORATION STOP; TAPER (CC) INLET x COMPRESSION FOR COPPER OUTLET. PIPE FOR 34" AND 1" TAPS. COMPACT TO 95% MAX DRY DENSITY PER ASTM D-1557. C. CONCRETE BLOCK(S) SUPPORT. APPROVED BY CITY. 3. SET BOX AT GRADE AND LEVEL WITH GRADE - PROVIDE FORD FB1000-3-Q FOR 3/4" SERVICE LINE E. 8-MIL PLASTIC POSITIVE DRAINAGE AWAY FROM BOX. FORD FB1000-4-Q FOR 1" SERVICE LINE 4. DOUBLE OR MULTIPLE SERVICES MUST BE NO MORE THAN 2 MUELLER B-25008, SPECIFY SIZE TYPE K SOFT COPPER WITH NO JOINTS FEET APART - 6" IN SIDEWALKS (WHERE APPROVED). FOR 34" DOUBLE METERS USE "Y" FITTING - MUELLER H-15343 1/4" x 1" OR FORD Y44-2430Q. FOR 1" DOUBLE METERS USE "Y" D. 5/8"x3/4" OR 1" METER SETTER 3/4" = FORD VBH92-15W-4M-33ZAQ FITTING - MUELLER H-15343 1"x1-1/2" OR FORD Y44-264 3/4"=MUELLER B-24104R2EFF1515 PACK JOINT. 1" = MUELLER B-241042G1515 5. METER LOCATIONS SHALL BE APPROVED BY CITY. AVOID VEHICLE TRAVEL AREAS WHENEVER POSSIBLE.
6. SERVICES SHALL BE INSTALLED BY THE CITY ON CITY OWNED 1" = FORD VBH94-15W-4M-44ZAQ PLASTIC CAP ALL TEES AND VALVES TO BE AIR-TESTED BEFORE TAP AT 120 PSI FOR 5 MINUTES. PVC JUMPER: DRILL - 1/4" HOLES SIZE-ON-SIZE TAPS ALLOWED ON DUCTILE IRON ONLY.
VALVES: SEE APPROVED MATERIAL LIST. 3/4" SETTER - 7 1/2" x 1" THRD PIPE. 7. SERVICES SHALL NOT BE TAPPED OFF HYDRANT OR FIRE SPRINKLER SYSTEM BRANCHES.
8. FILL METER BOX TO TOP WITH UN-COMPACTED CEDAR 1" SETTER - 10 3/4" X 1 1/4" THRD PIPE. PIPE MUST BE RESTRAINED OR BLOCKED. SEE APPROVED MATERIAL LIST. TAPPING TEE SENSUS 3/4" i-PERL, 7.5" LL, CCF SENSUS 1" i-PERL, 10.5" LL, CCF CITY SHALL INSTALL METER UNLESS OTHERWISE APPROVED. STAINLESS TAPPING TEE SHALL HAVE FULL-CIRCLE SEAL. ALL BOLTS SHALL BE OF THE SAME TYPE AND 10. CONTRACTOR SHALL CONNECT PIPING FROM HOUSE TO METER H. 2"x4"x8" BRICKS PLACED UNDER EACH QUALITY AS SUPPLIED BY THE MANUFACTURER OF THE TEE OR FITTINGS. PRIOR TO RADIO READ METER INSTALLATION. CORNER ON COMPACTED (FIRM) SUBGRADE. METER BOX: DFW1324CNP4-18 BODY DFW1324SL-4MA2 LID 11, ALL MULTIPLE METER BOXES THREE OR MORE MUST BE B. STEEL TAPPING TEE SHALL BE EPOXY COATED (SEE APPROVED MATERIAL LIST). ALL BOLTS SHALL BE OF THE SAME TYPE AND QUALITY AS SUPPLIED BY THE MANUFACTURER OF THE TEE OR FITTINGS. STEEL INDIVIDUALLY TAGGED. SECURE WITH WIRE-TIE TO LOWER LOCKING EAR OF SETTER. TAG MUST BE STAMPED OR TAPPING TEE SHALL BE INSTALLED ON DUCTILE IRON PIPE ONLY. ENGRAVED WITH HOUSE NUMBER. FONT SIZE MINIMUM ½". 12. ALL MATERIAL SHALL BE N.L. STANDARD STANDARD DATE: 4/1/19 3/4" AND 1" METER SERVICE DETAIL NO. DETAIL NO TAPPING TEE FOR DOMESTIC, IRRIGATION, AND FIRE SCALE: NTS W-09 W-08 SCALE: NTS CONNECTION AT SEWER MAIN SEE STREET PATCH DETAILS / SAWCUT (TYP.) ROW OR PAVED AREAS UNTRAVELED AREAS SINGLE SERVICE s" tee outlet (side)--EXIST. PAVEMENT FINISH TO EXISTING GRADE WITH 12" OF MATCHING MATERIAL. BEDDING GRAVEL, COMPACTED TRENCH BACKFILL TO BE COMPACTED 0 85% OF MAX. DENSITY IN ACCORDANCE WITH ASTM D-1557 MODIFIED PROCTOR, PLACED IN LOOSE LAYERS NO MORE THAN 12" THICK AND NOT ADJACENT TO PAVED AREAS (SEE NOTE 1). TRENCH BACKFILL TO BE COMPACTED TO 95% OF MAX. DENSITY IN ACCORDANCE WITH ASTM D-1857 MODIFIED PROCTOR, PLACED IN LOOSE LAYERS NO MORE THAN 8" THICK (SEE NOTE 1). PLUGGED STUB ON SEWER MAIN BENCH AS NEEDED FOR SHORING OR TRENCH BOX (TYP.) WHEN DEPTH IS 4 FT. AND GREATER 2x4 CUT TO LENGTH 8 ____ DOUBLE SERVICE PAINTED WHITE 2' ABOVE FINISHED GROUND F TEM S 之川三川三川三井川三 SEE STANDARD DETAIL G-14 (PIPE BEDDING) FILL VOIDS BY WORKING
MATERIAL UNDER PIPE. HAND
COMPACT TO 6" ABOVE CROWN
OF PIPE.

SEE NOTE 2.

NOTES:

1. TRENCH BACKFILL MATERIAL TO BE WELL GRADED "COMMON BORROW" FREE OF CLODS OR ROCKS GREATER THAN 3" IN ANY DIMENSION WITH A MOISTURE CONTENT WITHIN 2% OF OPTIMUM — WSDOT STD SPEC 9—03.14 (3).

2. MAXIMUM WIDTH OF TRENCH AT TOP OF PIPE.

* 30" FOR PIPE UP TO AND INCLUDING 12" NOMINAL DIAMETER.

* 0.D. PLUS 16" FOR PIPE LARGER THAN 12" NOMINAL DIAMETER.

3. COF EQUAL TO CADMAN PROFLOW 5 HOUR 11021 REQUIRED WHEN CROSSING EXISTING STREETS.

4. COMPACTION TESTING AND PROCTOR REQUIRED. ONE TEST PER LIFT PER 100' OF TRENCH. MINIMUM 2 TESTS PER LIFT.


5. MAXIMUM 1YPICAL TRENCH DEPTH IS 48". DEEPER TRENCHES MUST BE IDENTIFIED VIA SEPARATE UTILITY PROFILE DESIGN AND APPROVED BY THE CITY ENGINEER OR DESIGNEE.


6. COMPACTION TESTING AT DEPTHS GREATER THAN 4' IN TRENCHES MAY BE ACCOMPLISHED BY MAINTAINING A COMPACTION PATTERN PROVEN TO MEET COMPACTION REQUIREMENTS.


7. TRENCHES LESS THAN 2' WIDE REQUIRE COF.


TYPICAL PIPE

TRENCH DETAIL

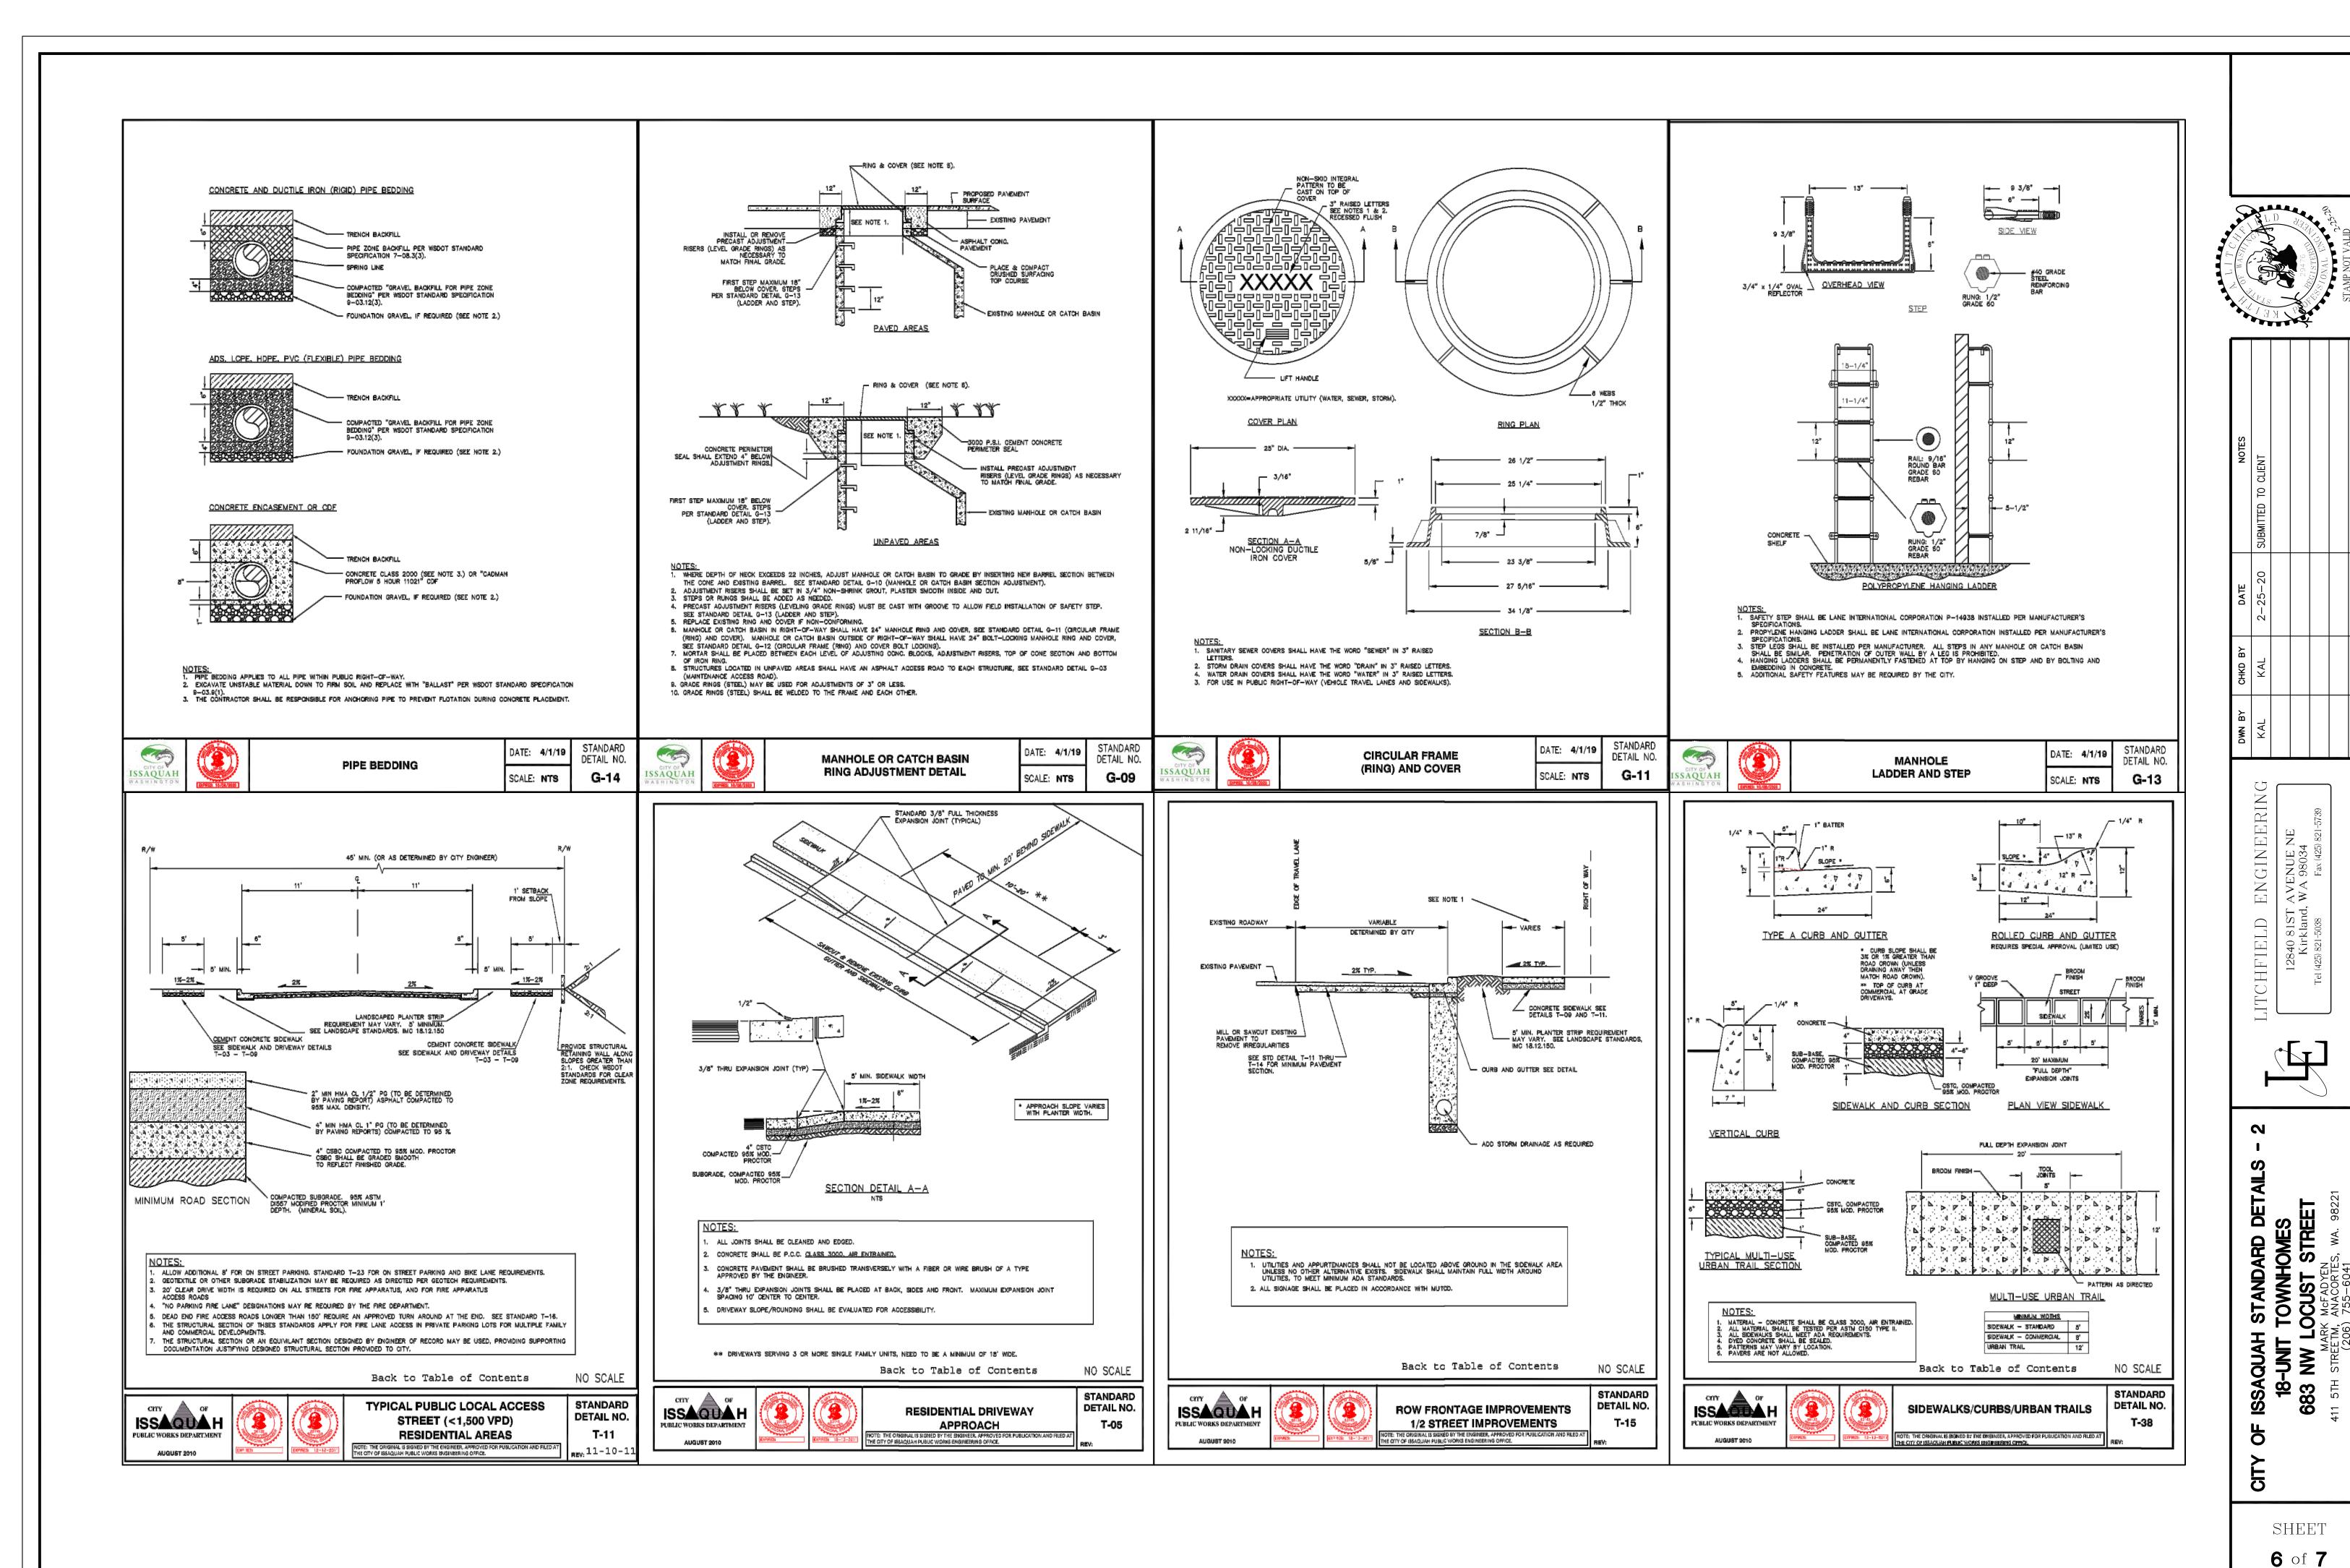

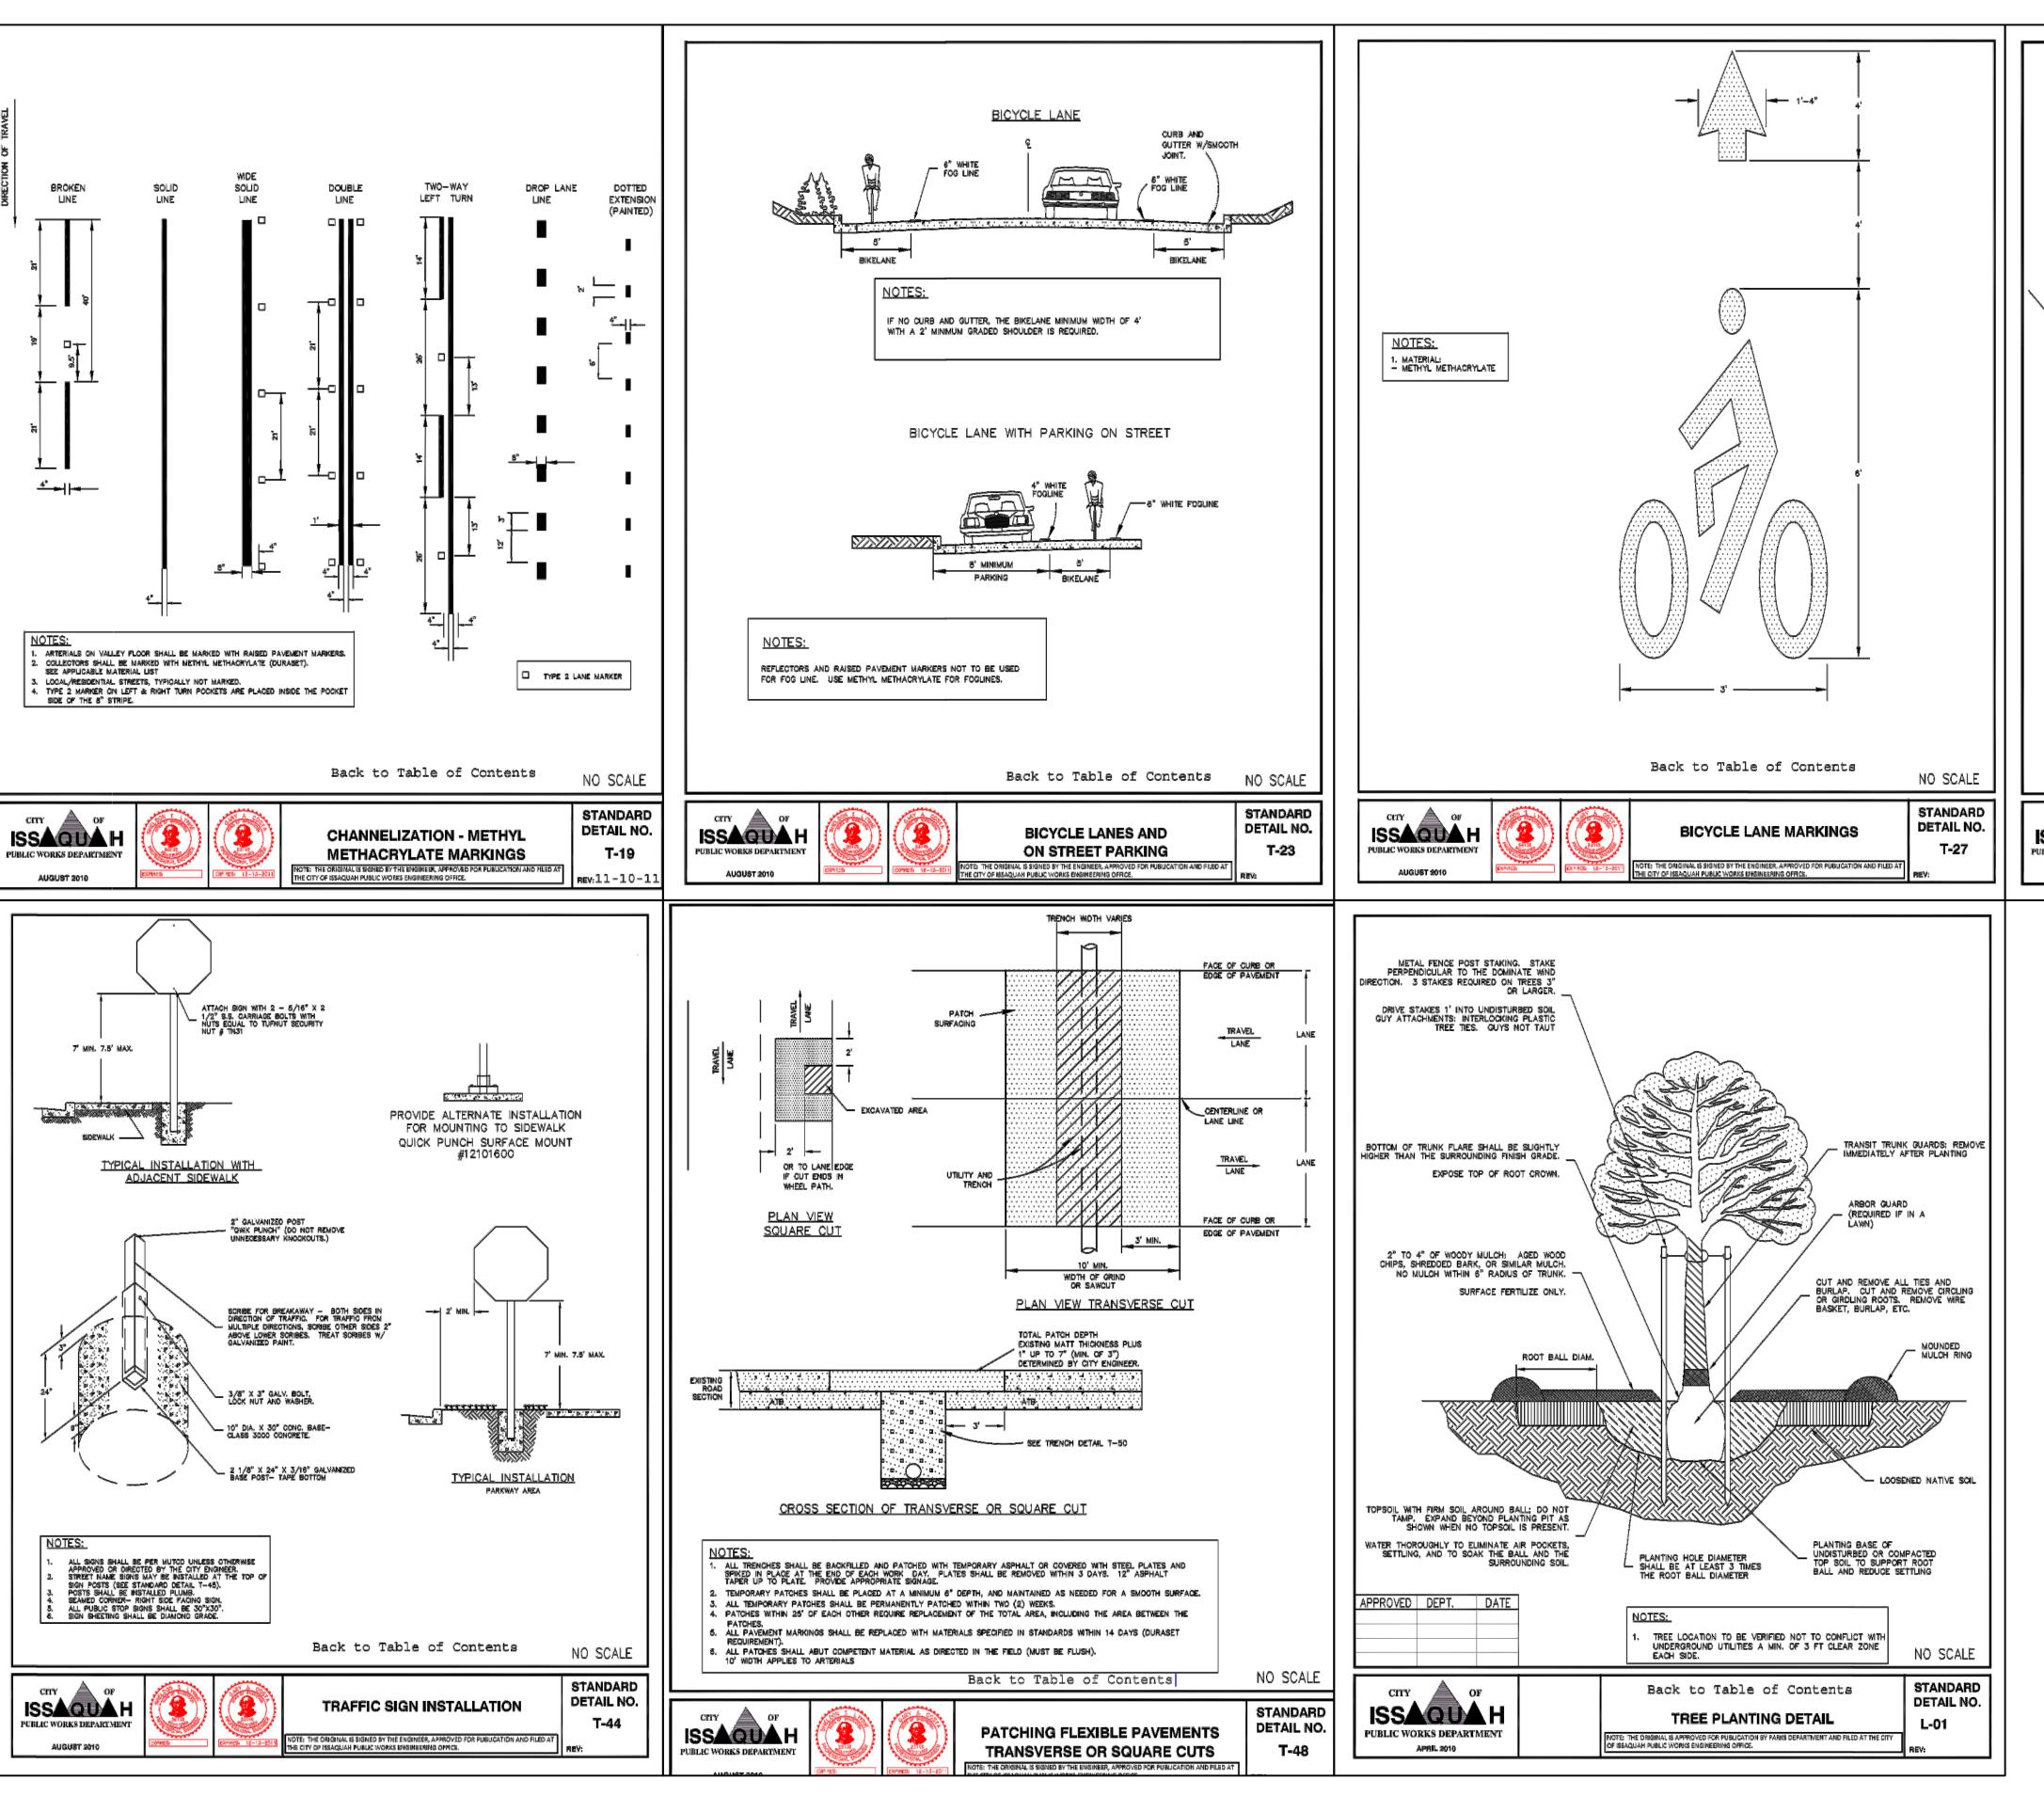

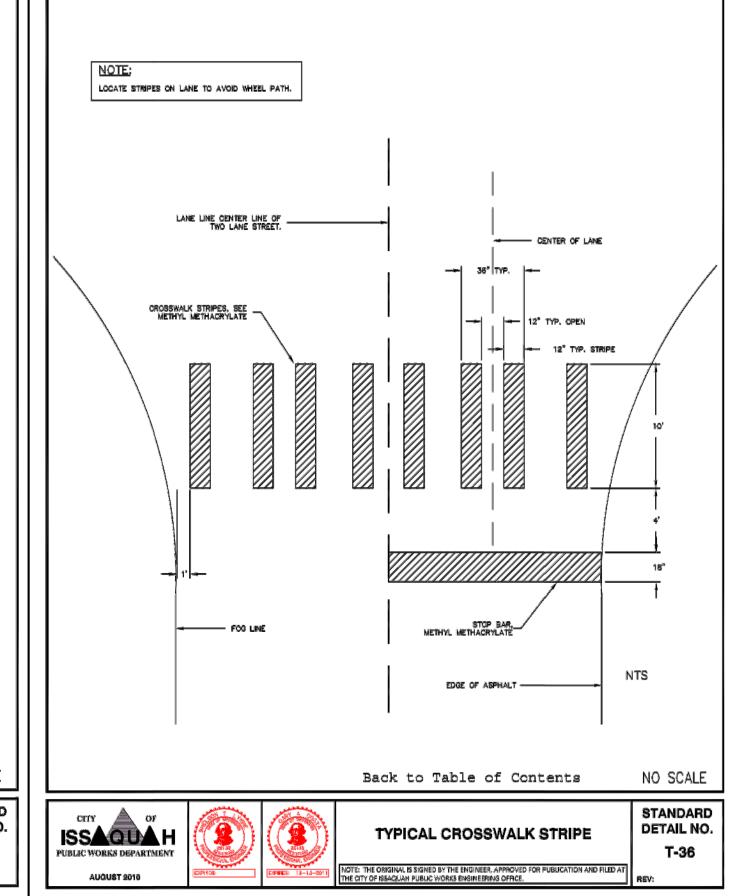

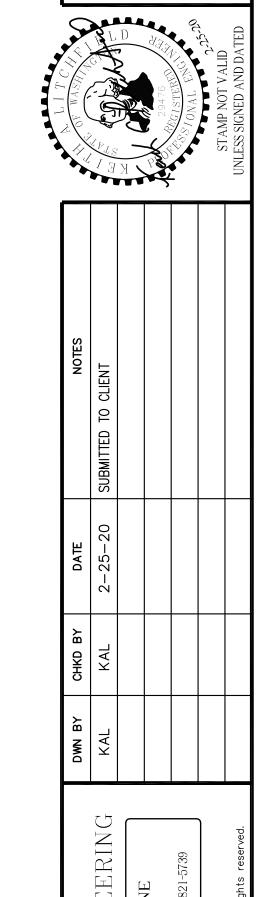

S - 3

LITCHFIELD ENGII


12840 81ST AVENU

Kirkland, WA 980

Tel (425) 821-5038 Fax (425)

Y OF ISSAQUAH STANDARD DETAILS – 18-UNIT TOWNHOMES
683 NW LOCUST STREET
MARK MCFADYEN
411 5TH STREETM, ANACORTES, WA. 98221
(206) 755-6041

SHEET **7** of **7**

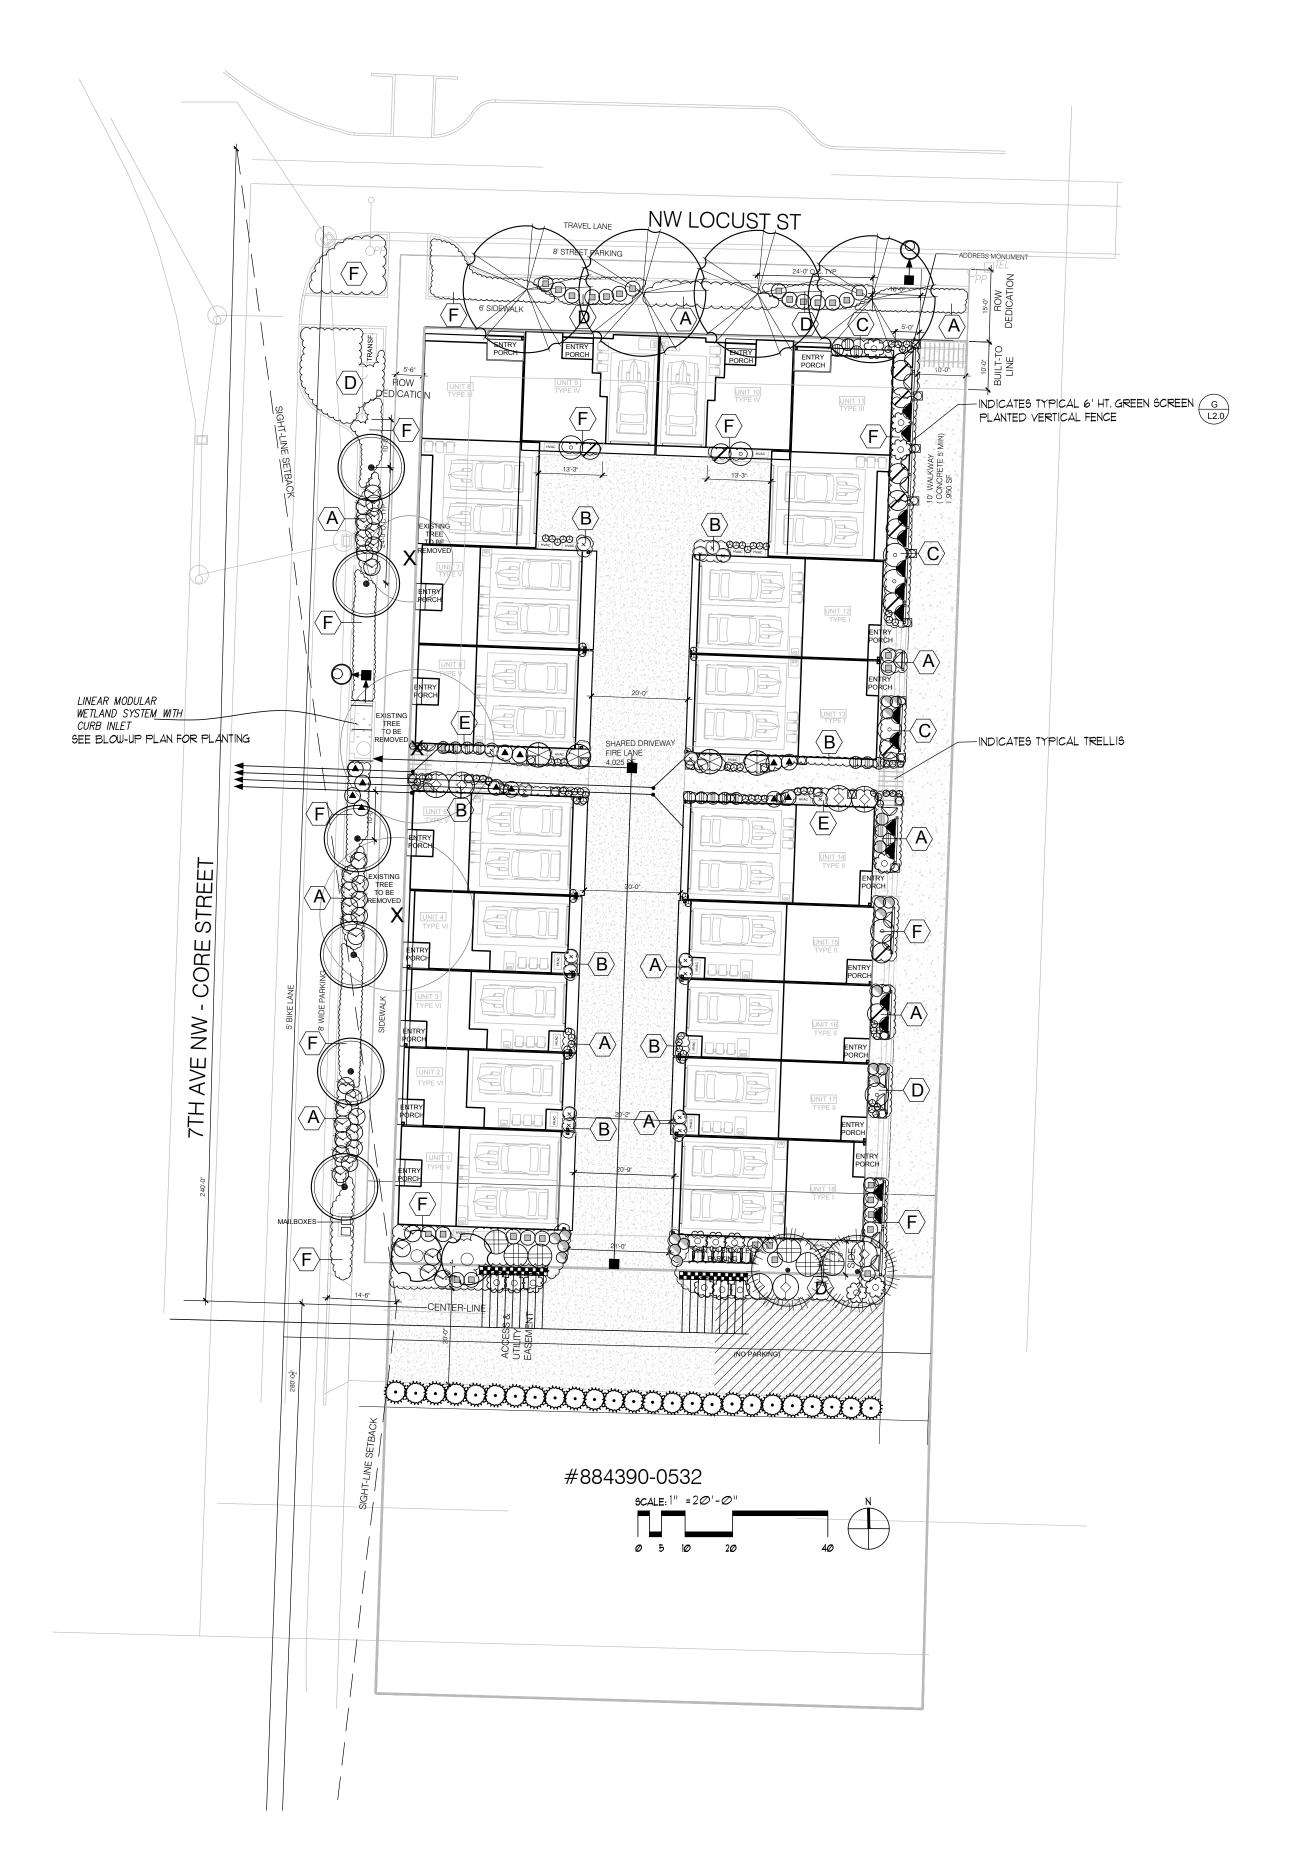

PLANTING SCHEDULE

SYMBOL	BOTANICAL NAME/ COMMON NAME	SIZE AT PLANTING	QTY.	NATIVE/ ADAPTIVE
TREES				
X	INDICATES EXISTING TREE TO BE REMOVED			
	AMELANCHIER X GRANDIFLORA 'AUTUMN BRILLIANCE' / SERVICEBERRY TREE FORM	3" CALIPER, TREE FORM, BRANCHED AT 1' HT.	4	YES
	ZELKOVA SERRATA 'FASTIGIATA' / COLUMNAR ZELKOVA	3" CALIPER, TREE FORM, BRANCHED AT 1' HT.	6	NO
•	CHAMAECYPARIS OBTUSA 'GRACILIS' / SLENDER HINOKI CYPRESS	8' HT. 3" CALIPER	2	NO
	ACER GINALLA 'FLAME' / AMUR MAPLE	8' HT. , MULTI-STEM, 3@ 1" CALIPER	2	NO
SHRUBS				
	ENKIANTHUS CAMPANULATUS 'RED BELLS'/ ENKIANTHUS	24" HT., 5-GAL POT	4	NO
	RIBES SANGUINIUM / RED FLOWERING CURRENT	24" HT., 5-GAL POT	6	YES
\bigcirc	RHODODENDRON OCCIDENTALE / WESTERN AZALEA	18" HT., 3-GAL POT	٦	YES
	MAHONIA NERVOSA/ LONG-LEAF MAHONIA	12" HT., 2-GAL POT	19	YE9
\bigcirc	POLYSTICHUM MUNITUM/ SWORD FERN	12" HT., 2-GAL POT	11	YES
	LAVANDULA ANGUSTIFOLIA 'HIDCOTE' / LAVENDER	12" HT., 2-GAL POT	18	NO
(BLECHNUM SPICANT / DEER FERN	18" HT., 2-GAL POT	12	YES
\bigcirc	CORNUS STOLONIFERA KELSEYI'/DWARF RED-TWIG	12" HT., 2-GAL POT	86	YES
	ILEX CRENATA 'CONVEXA' / JAPANESE HOLLY	18" HT., 3-GAL POT	25	NO
\otimes	HELICTOTRICHON SEMPERVIRENS / BLUE OAT GRASS	12" HT., 2-GAL POT	37	NO
0	CALAMAGROSTIS ACUTIFLORA 'KARL FORSTER' / FEATHER REED GRASS	18" HT., 2-GAL POT	1	NO
	PENNISETUM ALOPECUROIDES 'HAMLIN /FOUNTAIN GRASS	12" HT., 2-GAL POT	31	NO
\bigotimes	SKIMMIA JAPONICA / SKIMMIA	12" HT., 3-GAL POT	דו	NO
©	CROCOSMIA / MONTBRETIA	12" HT., 1-GAL POT	15	NO
	CLEMATIS MONTANA / ANEMONE CLEMATIS	3" HT., STAKED I-GAL POT	15	NO


	AKEBIA QUINATA / / FIVELEAF AKEBIA	3" HT., STAKED 1-GAL POT	15	NO
VETLAND PLA	<u>INTS</u>	1		SPACING
	CAREX OBNUPTA / SLOUGH SEDGE	4-INCH POT		6" O.C.
	JUNCUS TENUIS / SLENDER RUSH	4-INCH POT		6" O.C.
GROUNDCOVERS				SPACING
A	LIRIOPE SPICATA / CREEPING LILY TURF	4-INCH POT		1'-Ø" O.C.
$\langle B \rangle$	EPIMEDIUM X RUBRUM/ HYBRID EPIMEDIUM	4-INCH POT		1'-Ø" O.C.
\overline{C}	GAULTHERIA SHALLON / SALAL	4-INCH POT		1'-Ø" O.C.
D	RUBUS CALYCINOIDES / EVERGREEN BRAMBLE	4-INCH POT		1'-Ø" O.C.
E	GAULTHERIA PROCUMBENS / WINTERGREEN	4-INCH POT		1'-Ø" O.C.
F	FRAGARIA CHILOENSIS / SAND STRAWBERRY	4-INCH POT		1'-Ø" O.C.

INDICATES 4' HT. GREEN SCREEN PLANTED VERTICAL FENCE (G) L2.0



LIGHTING LEGEND

D INDICATES LOW-YOLTAGE LED PATHWAY LIGHT

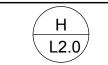

TREE DENSITY CALCULATION

REQUIRED DENSITY: 4 SIGNIFICANT TREES / 5,000 S.F. SITE AREA: 24,901 S.F. / 5,000 = 5 × 4 = 20 TREES @ 6" DBH= 120" DBH TOTAL

EXISTING TREES TO BE SAVED: Ø

PROPOSED ON-SITE NEW TREES: 14 @ 3"= 42.0" DBH TOTAL

PROPOSED OFF-SITE NEW TREES: 26 @ 3"= 78.0" DBH TOTAL

PLANTING NOTES AND SEQUENCE:

1. ALL NEW PLANTINGS SHALL BE IRRIGATED FOR THE ESTABLISHMENT PERIOD WITH SURFACE INSTALLED DRIP AUTOMATIC IRRIGATION EQUIPMENT WITH RAIN SHUT-OFF DEVICE. COMPLETE INSTALLATION OF IRRIGATION SYSTEM PRIOR TO PLANTING OF VEGETATION. NO TRENCHING ALLOWED WITHIN CRITICAL ROOT ZONE OF EXISTING TREES.

2. ALL NEW PLANTING AREA SUBGRADES, EXCEPT THOSE WITHIN THE CRITICAL ROOT ZONE OF ALL EXISTING TREES, SHALL BE TILLED TO A DEPTH OF 12"AND ALL LARGE ROCKS, STICKS, ROOTS AND DEBRIS SHALL BE REMOVED FROM THE TILLED AREA.

3. ALL NEW PLANTING AREAS, EXCEPT THOSE WITHIN THE CRITICAL ROOT ZONE OF ALL EXISTING TREES, SHALL RECEIVE MINIMUM 2" OF COMPOST SOIL AMENDMENT TILLED INTO THE TOP 6" OF IMPORTED SANDY LOAM SOIL. ALL AREAS SHALL RECEIVE MIN. 2" OF ORGANIC MULCH COVER.

4. STAKE OR MARK PLANT LOCATIONS AS INDICATED ON THIS PLAN. AVOID ALL CONFLICTS WITH UTILITY LOCATIONS AND ADJUST PLANT LOCATIONS AS REQUIRED.

5. INSTALL PLANTS AS DETAILED. APPLY SUFFICIENT WATER FOR ESTABLISHMENT OF HEALTHY PLANT GROWTH.



INCORPORATED P.S.

LANDSCAPE ARCHITECTURE URBAN DESIGN SITE PLANNING PARKS AND RECREATION PLANNING 12610 NE 104TH ST. KIRKLAND WA 98033 PH: 425.454.5723 FX: 425.822.3525 E-: jgm@jgm-inc.com

BUILD 18 TOWNHOMES LOCUST AND 7TH AVE 683 NW LOCUST AVE ISSAQUAH, WA


REVISIONS/DRAWING ISSUES:

Drawn by: CL Checked by: CL




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PLANTING PLAN

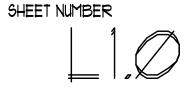

BLOW-UP PLAN LINEAR MODULAR WETLAND SYSTEM

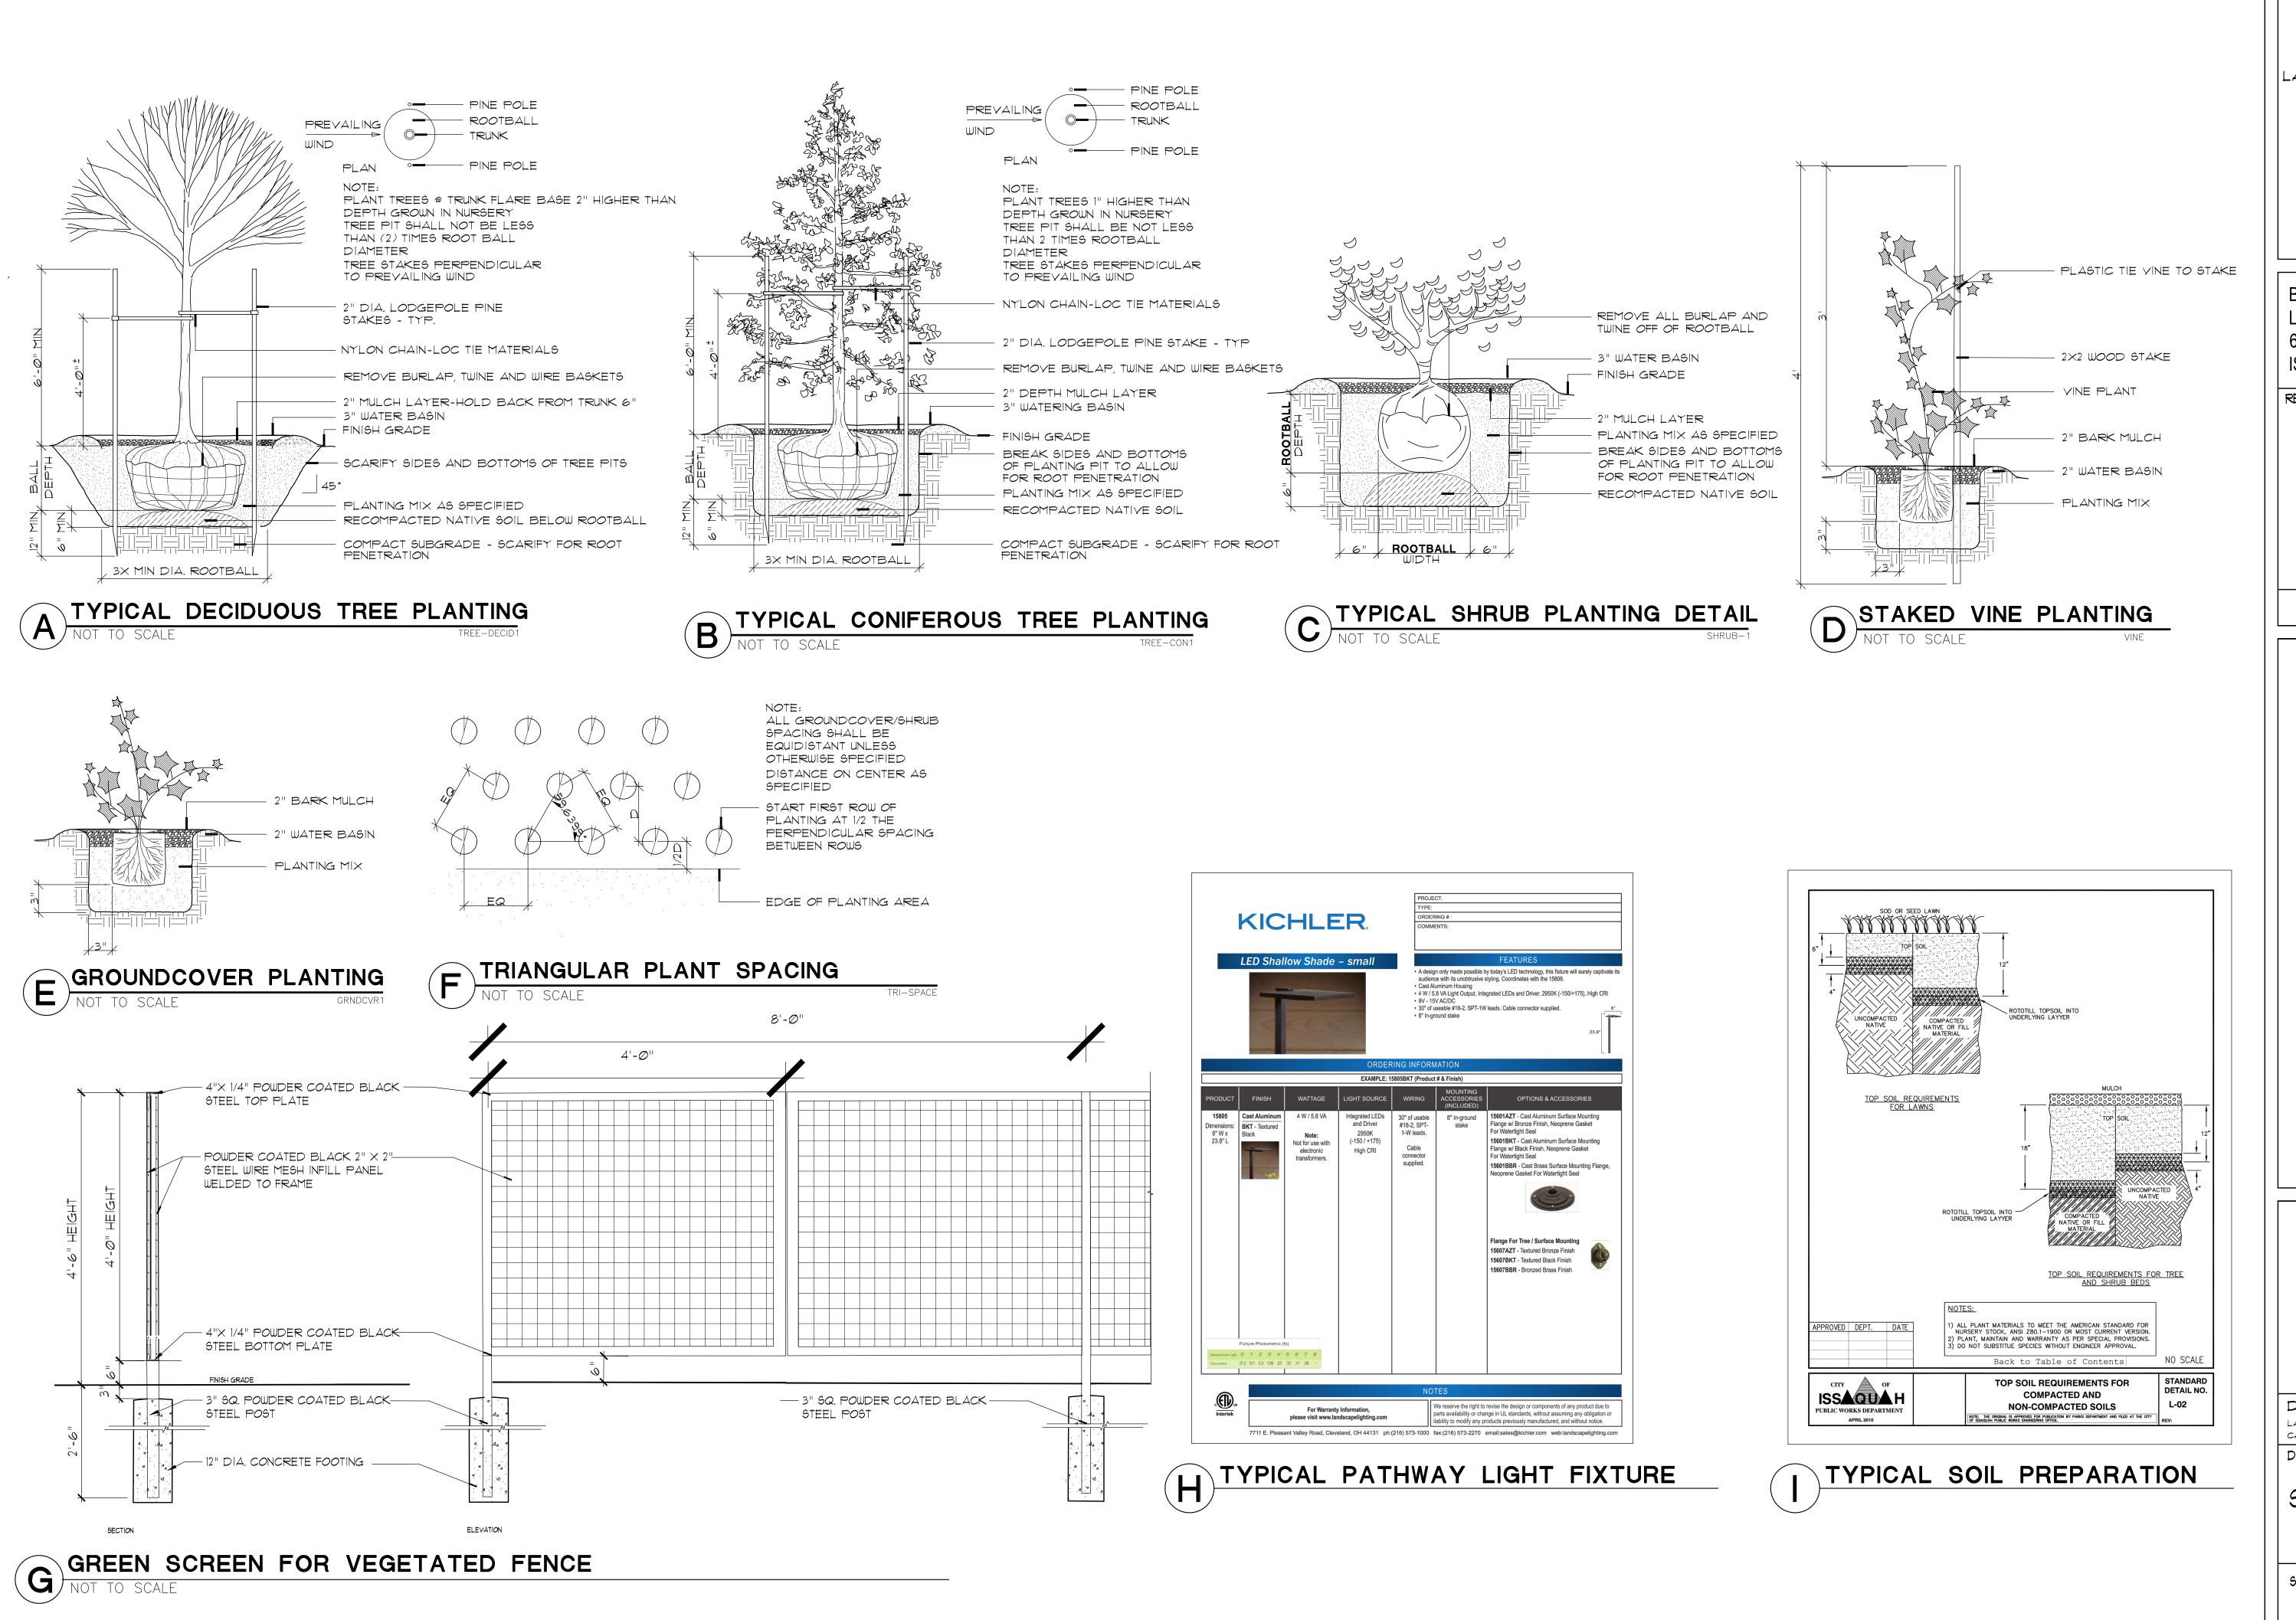

LANDSCAPE ARCHITECTS

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REVISIONS/DRAWING ISSUES:

Drawn by: CL Checked by: CL

WASHINGTON REGISTERED LANDSCAPE ARCHITECT Craix A. Leis CERTIFICATE NO. 442

DATE: 3-12-2020 LAST UPDATE: CAD FILE:

DRAWING TITLE

SITE DETAILS

SHEET NUMBER